

SPECIAL USE REPORT

► FILE #: 3-E-25-SU AGENDA ITEM #: 19

AGENDA DATE: 3/13/2025

► APPLICANT: PIER GROUP, LLC

OWNER(S): PIER Group, LLC

TAX ID NUMBER: 109 L D 006 View map on KGIS

JURISDICTION: City Council District 1
STREET ADDRESS: 4507 SEVIERVILLE PIKE

► LOCATION: South side of Sevierville Pike, east of E Red Bud Rd

► APPX. SIZE OF TRACT: 15.67 acres
SECTOR PLAN: South City

GROWTH POLICY PLAN: N/A (Within City Limits)

ACCESSIBILITY: Access is via Sevierville Pike, a major collector street with 20-ft of pavement

width within a 44-ft right-of-way.

UTILITIES: Water Source: Knoxville Utilities Board

Sewer Source: Knoxville Utilities Board

FIRE DISTRICT: Knoxville Fire Department

WATERSHED: Toll Creek

ZONING: AG (General Agricultural), HP (Hillside Protection Overlay)

EXISTING LAND USE: Agriculture/Forestry/Vacant Land

PROPOSED USE: Campground (revision of previously approved Special Use 4-E-23-SU)

HISTORY OF ZONING: In 2021 the property was rezoned from RN-1 (Single-Family Residential

Neighborhood) / HP (Hillside Protection Overlay) to AG (Agricultural) / HP (Hillside Protection Overlay) (5-E-21-RZ). In 2022 part of the parcel was rezoned from RN-1 (Single-Family Residential Neighborhood)/HP (Hillside Protection) to AG (General Agricultural)/HP (Hillside Protection) (1-F-22-RZ).

SURROUNDING LAND USE AND ZONING:

North: Single family residential, multifamily residential, public parks - RN-1

(Single-Family Residential Neighborhood), NA (Natural Areas), HP

(Hillside Protection Overlay)

South: Agricultural/forestry/vacant, multifamily residential, public parks -

RN-1 (Single-Family Residential Neighborhood), RN-3 (General Residential Neighborhood), © former planned district, NA (Natural

Areas), HP (Hillside Protection Overlay)

East: Agricultural/forestry/vacant, public parks - RN-1 (Single-Family

Residential Neighborhood), NA (Natural Areas), HP (Hillside

Protection Overlay)

West: Agricultural/forestry/vacant, single family residential, rural

residential - RN-1 (Single-Family Residential Neighborhood), HP

(Hillside Protection Overlay)

The property is part of Knoxville's Urban Wilderness trail and park system, and it abuts Ijams Nature Center to the north and Marie Myers Park to the east and south. Baker Creek Preserve and South-Doyle Middle School lie to the west, and the William Hastie Natural Area lies to the south. Aside from public parks, the area features a mix of rural, single-family, and multifamily residential uses, with some commercial uses to the west near the exit with James White Parkway.

STAFF RECOMMENDATION:

- ▶ APPROVE the Special Use for a campground with a maximum of 6 campsites, 15 tiny mobile home cabins, 6 cabins, 1 bath house, and 1 sauna in the locations depicted on the site plan, subject to 6 conditions.
 - 1. Meeting the requirements of the principal use standards for campgrounds (Article 9.3.C) of the City of Knoxville Zoning Ordinance.
 - 2. Obtaining Alternative Landscape Design approval before permits are issued that shows the location and species of existing and proposed trees that will be used to meet the required Class B buffer yard per Section 12.8.
 - 3. Meeting the requirements of Article 11 (Off-Street Parking) of the City of Knoxville Zoning Ordinance.
 - 4. Meeting all applicable requirements of the City of Knoxville Department of Plans Review and Inspections.
 - 5. Meeting all applicable requirements of the City of Knoxville Department of Engineering.
 - 6. Meeting all applicable requirements of the City of Knoxville Zoning Ordinance.

With the conditions noted above, this request meets the requirements of the AG zone, the principal use standards for campgrounds, and the criteria for approval of a special use.

COMMENTS:

This is a revision of the previously approved The Drop Inn campground on Sevierville Pike west of Marie Meyers Park (4-E-23-SU). The proposal is for a maximum of 6 campsites, 15 tiny mobile home cabins, 6 cabins, 1 bath house, and 1 sauna, as shown in the site plan. The tiny mobile home cabins are not on permanent foundations and are movable structures, while the cabins are permanent structures. This proposal is specific to providing the type of camping and cabin amenities presented in this application.

PRINCIPAL USE STANARDS

The principal use standards for campgrounds (Article 9.3.C) include the following. (Staff notes in parenthesis.)

- 1. The minimum area for a campground is three acres. (The site is approximately 15.6 acres.)
- 2. Campgrounds must comply with all applicable state and city regulations including those governing the installation, construction, and/or operation of swimming pools, water supply, sewage disposal, food storage and services, plumbing, structures, electrical wiring, and fire prevention. (Proof of compliance is required during permitting. Bath house and cabins will have water, sewer, and electricity.)
- 3. Management headquarters, recreational facilities, coin operated laundry facilities, cabins for counselors, overnight accommodations, living space, and other uses and structures customarily associated with the operation of a campground are permitted. (The proposed structures are for overnight accommodation and office use and are amenities customarily associated with campground operations.)
- 4. Storage of equipment must be within enclosed structures. (This will be required during permitting.)
- 5. Year-round residency is prohibited at any campground. The use of camping units or sites as principal residences is prohibited. This excludes any structures erected specifically for a caretaker or campground ranger, which may be a year-round residency. (There are no proposed structures for year-round residency.)
- 6. A 25-foot perimeter setback from the lot line of the campground is required. No structures or campsites are allowed within this setback. The perimeter setback must be landscaped per the standards of a Class B buffer yard per Section 12.8. (Existing and new vegetation can be used to meet the buffer yard standard. The buffer is required between any campsite, common campground use area, parking area, and adjacent property lines as depicted on the attached site plan.)

STANDARDS FOR EVALUATING A SPECIAL USE (ARTICLE 16.2.F.2.)

1) THE USE IS CONSISTENT WITH ADOPTED PLANS AND POLICES, INCLUDING THE GENERAL PLAN AND THE ONE-YEAR PLAN.

A. This property is located next to Knoxville's Urban Wilderness park system. The campground use is consistent with the General Plan's development policy 9.2, which encourages development practices that fit the natural landscape, minimizing the loss of trees, woodlands, and wildlife habitat.

B. The One Year Plan and South City Sector Plan designation for this site is LDR (Low Density Residential)

- and HP (Hillside Protection). AG zoning that the applicant is requesting to develop under can be considered under the LDR land use designation.
- C. The property is located within the HP (Hillside Protection). The proposed development will require 3.2 acres of land disturbance, which is in compliance with the permitted disturbance of 4.02 acres.
- 2) THE USE IS IN HARMONY WITH THE GENERAL PURPOSE AND INTENT OF THIS ZONING CODE.
- A. The AG (General Agricultural) zoning district is intended to provide for agricultural uses that comprise an important part of the economy of Knoxville. The intent is to permit lands best suited for agriculture to be used for agriculture purposes, and prevent the encroachment of incompatible land uses on farm lands and protect the physical and economic well-being of agricultural operations.
- B. A campground is permitted as a special use in the AG zone and must meet the principal use standards of (Article 9.3.C.) as outlined above and the standards for evaluating a special use (Article 16.2.F.2.) This proposal is in compliance and has obtained Alternative Landscape Design approval to use the existing vegetation.
- C. The property is within the HP (Hillside Protection) overlay district. The proposed development will require minimal land disturbance and is in compliance with the HP overlay standards.
- 3) THE USE IS COMPATIBLE WITH THE CHARACTER OF THE NEIGHBORHOOD WHERE IT IS PROPOSED, AND WITH THE SIZE AND LOCATION OF BUILDINGS IN THE VICINITY.
- A. The subject property is on a major collector road with Knoxville's Urban Wilderness park and trail system to the east, north, and south. Single family residential homes are along the northern and western boundaries.
- B. The campsite loop "B" is the location closest to the adjacent house at a distance of approximately 190 ft to the west and 375 ft from the closest house to the northwest.
- C. The campground will be screened from the view of nearby homes using the existing tree canopy. Additionally, adjacent properties also have dense vegetation.
- 4) THE USE WILL NOT SIGNIFICANTLY INJURE THE VALUE OF ADJACENT PROPERTY OR BY NOISE, LIGHTS, FUMES, ODORS, VIBRATION, TRAFFIC, CONGESTION, OR OTHER IMPACTS DETRACT FROM THE IMMEDIATE ENVIRONMENT.
- A. Lights should not impact the adjacent properties. Lighting will be limited to small wall packs on tiny home mobile cabins and small wall packs at cabins, with similar lighting to the single family houses in the area. The campground will not include any large pole-mounted lights and will only include limited lighting at the bath house and pathway lighting. The exterior light fixture that is closest to a property line is the cabin porch light, which is approximately 60-ft from the property line at the road, and approximately 138-ft from the west property line, which includes the tree canopy buffer. Additionally, building finishes are muted and darker colors, which will not reflect the lights.
- B. Vehicular traffic should be minimal daily as there are only 1.3 motor vehicle parking spaces per campsite/cabin space (34 parking spaces per campsite/cabin).
- C. There may be odors and noises from people grilling and around campfires, but this would not be uncommon in a residential setting.
- 5) THE USE IS NOT OF A NATURE OR SO LOCATED AS TO DRAW SUBSTANTIAL ADDITIONAL TRAFFIC THROUGH RESIDENTIAL STREETS.
- A. Motor vehicular access to the site is via Sevierville Pike, a major collector street, so it will not draw substantial additional traffic through residential streets.
- B. This site is within the School Parental Responsibility zone. The city will waive the sidewalk construction requirement, as this will not be a residential development. If sidewalks are required along this property in the future, the driveway will be built to ADA standards.
- 6) THE NATURE OF DEVELOPMENT IN THE SURROUNDING AREA IS NOT SUCH AS TO POSE A POTENTIAL HAZARD TO THE PROPOSED USE OR TO CREATE AN UNDESIRABLE ENVIRONMENT FOR THE PROPOSED USE.
- A. There are no known uses in the area that could be a potential hazard or create an undesirable environment for future uses on this site.

ESTIMATED TRAFFIC IMPACT: Not required.

ESTIMATED STUDENT YIELD: Not applicable.

The Planning Commission's approval or denial of this request is final, unless the action is appealed to the Knoxville City Council. The date of the Knoxville City Council hearing will depend on when the appeal application is filed.


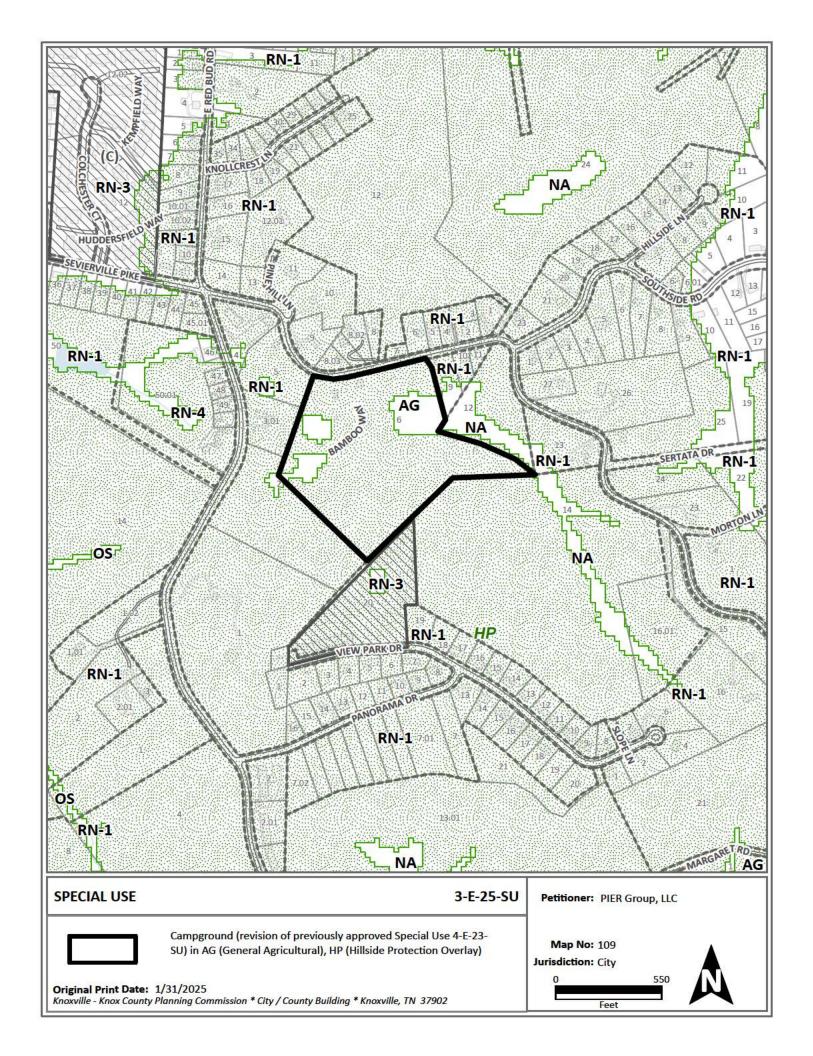



Exhibit A. Contextual Images





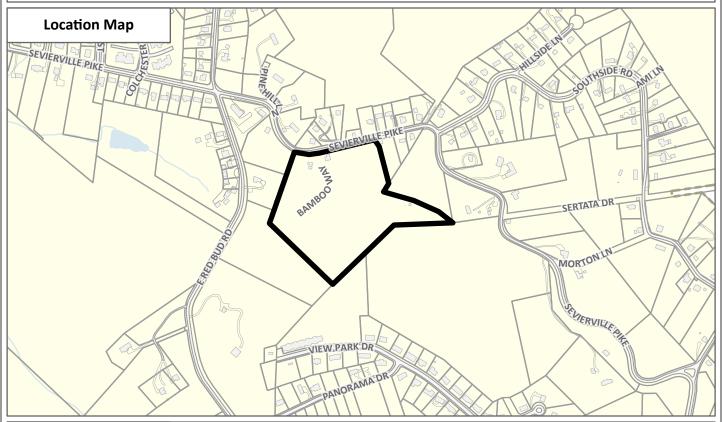


Case boundary

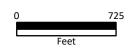



Staff - Slope Analysis Case: 3-E-25-SU

CATEGORY	SQFT	ACRES	RECOMMENDED DISTURBANCE BUDGET (Percent)	DISTURBANCE AREA (Sqft)	DISTURBANCE AREA (Acres)
Total Area of Site	682,476.5	15.67			
Non-Hillside	90,745.4	2.08	N/A		
0-15% Slope	51,468.7	1.18	100%	51,468.7	1.18
15-25% Slope	110,106.8	2.53	50%	55,053.4	1.26
25-40% Slope	257,290.3	5.91	20%	51,458.1	1.18
Greater than 40% Slope	172,865.3	3.97	10%	17,286.5	0.40
Ridgetops					
Hillside Protection (HP) Area	591,731.1	13.58	Recommended disturbance budget within HP Area	175,266.7	4.02
			Percent of HP Area	29.0	5%

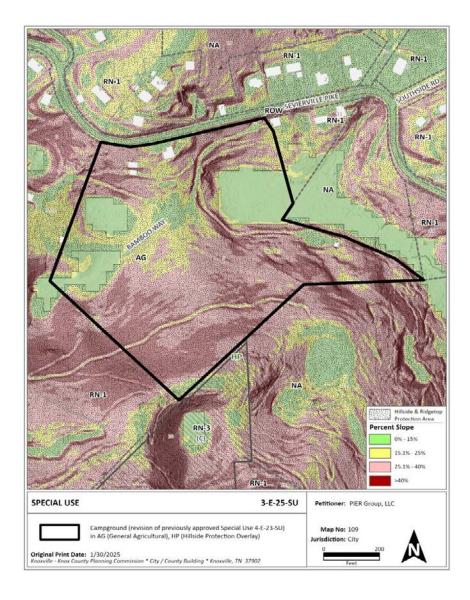

THE DROP INN SPECIAL USE REVIEW 4507 SEVIERVILLE PIKE KNOXVILLE, TENNESSEE 37920





SPECIAL USE SUBMITTAL 3-E-25-SU

If THIS DOCUMENT IS NOT SIGNED, SEALED, DATED, IT MAY NOT BE USED FOR CONSTRUCT

DRAWING INDEX

COO1 COVER SHEET


C002 GENERAL NOTES AND LEGENDS
C101 SITE LAYOUT PLAN (OVERALL)

C201 SITE GRADING & DRAINAGE PLAN (OVERALL)

C301 DRIVEWAY PROFILES

C401 TURNING MOVEMENTS AND SIGHT DISTANCE

C501 CONCEPTUAL SITE UTILITY PLAN (WATER & SEWER)

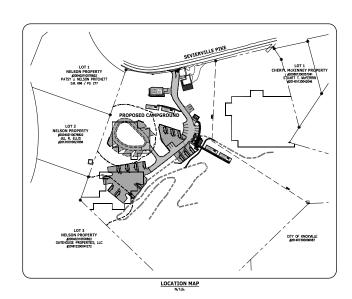

PROPERTY DATA							
PROPERTY OWNER	THE DROP INN KNOX, LLC 408 E RED BUD ROAD KNOXVILLE, TN 37920						
KNOXVILLE CLT. MAP NO.	109						
PARCEL NUMBER	6.00						
JURISDICTION	KNOX COUNTY, CITY OF KNOXVILLE, CITY BLOCK #29220						
ZONING	AG, "AGRICULTURAL ZONING"						
AREA	15.6± AC. TOTAL (2.66 AC. DISTURBED)	_					

THE DROP INN CAMPGROUND
4507 SEVIENVILLE PIKE
KNOXVILLE, TENNESSES 37920

MULEU



10025 Investment Drive, Suite 12 Knoxville, TN 37932

865.670.8555 www.cci-corp.com

PIER GROUP PARTNERS IN EVERYTHING RECREATION 121 E JACKSON AVENUE

CCI PROJ. NO. 01821-0000
DATE: JANUARY 24, 2025
PN/PC: 1 HUNT

SITE LAYOUT PLAN (OVERALL)

C101

- SITE DEMOLITION NOTES:

 AREA CONTROLLAND ADDRESSABLE MITTERS AS SHOWN

 AREA CONTROLLAND ADDRESSABLE MITTERS AS SHOWN

 ARROSS AND ADDRESSABLE ADDRESSABLE MITTERS

 SEE AND ADDRESSABLE ADDRESSABLE ADDRESSABLE

 SEE AND ADDRESSABLE ADDRESSABLE

 SEE AND ADDRESSABLE

 SEE AND ADDRESSABLE

 ADDRESSAB

SITE LAYOUT NOTES:

- THE BOUNDARY AND TOPOGRAPHIC DATA SHOWN WAS PROVIDED BY CANNON & CANNON, INC. DATED NOVEMBER 1,
- 1. THE BOADDARY AND TROPOGRAPHIC DATA SHOWN MISS PROPRIED BY CHRONING CAMPON, NO CADED MORRISOR, PROPRIED BY COMEN OF CAMPON CAMPON AND THE MORRISON FOR ANY CAMPON CAMPON

- 2. TOTAL MEAN ST 15.07 MORES THE TOTAL DISTINGENT ST 25.07 MORES THE TOTAL DISTINGENT ST 15.00 MORE ST 15.00 MORE

SITE GRADING AND EROSION CONTROL NOTES:

- THE BOUNDARY AND TOPOGRAPHIC DATA SHOWN WAS PROVIDED BY CANNON & CANNON, INC. DATED NOVEMBER 1,
- PRODUCED PS COMMON & CANNON, INC. DATED INFORMERS IT, DO ESTIMBING AND SEE SPROMMANTE LYSE ANDES. THE DOTAL SITE AND SEE STATES AND SEE STATES AND SEE STATES AND SEE STATES AND SEE SEASON AND SEED SEASON AND SEASON AND SEASON AND SEASON AND SEASON OF SEASON OF SEASON OF SEASON OF SEASON AND SEASON OF SEASON OF
- OFF-SIE OR OH-SIE AT A LOCATION DETERMINED BY THE OWN THE PROPERTY OF THE ATTEMPT OF THE PROPERTY OF THE PROPE

- ACCOMMANCE WITH THE SITE SPECIAL REPORT OF A
 A FAIR MAN LATER OF TOPICS, SMALL REPAIRED OFFE
 B. A FAIR MAN LATER OF TOPICS, SMALL REPAIRED OFFE
 BLANDINGS AS SOWN ON THE PROMISE GOODE
 BLANDINGS AS SOWN ON THE PROMISE GOODE
 BLANDINGS AS SOWN ON THE PROMISE GOODE
 BLANDINGS AS SOWN ON THE PROMISE MAY BE AND THE REPAIRED.
 BLANDINGS AS SOWN ON THE PROMISE MAY BE ADDRESS AS A
 BASE OF THE PROMISE AS A SOWN OF THE PROMISE AS A
 BASE OF THE PROMISE AS A SOWN OF THE PROMISE AS A
 BASE OF THE PROMISE AS A SOWN OF THE PROMISE AS A
 BASE OF THE PROMISE AS A SOWN OF THE PROMISE AS A
 BASE OF THE PROMISE AS A SOWN OF THE PROMISE AS A
 BASE OF THE PROMISE AS A SOWN OF THE PROMISE AS A
 BASE OF THE PROMISE AS A SOWN OF THE PROMISE AS A
 BASE OF THE PROMISE AS A SOWN OF THE PROMISE
 BLANDING TO BE CONTINUE.

 BASE OF THE PROMISE AS A SOWN OF THE PROMISE AS A
 BASE OF THE PROMISE AS A SOWN OF THE PROMISE AS A
 BASE OF THE PROMISE AS A SOWN OF THE PROMISE AS A SOW
- WHIN OR THE APPLY TEMPORATY SEEMS TO ALL
 SUS, STREAM, THE SEEMS WERE APPLY TEMPORATY SEEMS TO ALL
 SUS, STREAM, THE SEEMS WERE APPLY THE AND ALL CONTRIBUTION
 OPERATORS. WE COMPLETE AND ALL CONTRIBUTION
 OPERATORS. WILL OF WHICH THE SEEMS AREA.
 STREAM WHICH SHOW SHOWS OF EXCESSIVE MODION
 STREAM WHICH SHOW SHOWS OF EXCESSIVE MODION
 STREAM WHICH SHOWS THE APPLICATION OF THE AP

SEEDING MIXTURE CHART:

TEMPORARY SEED	ING MIXTURES SHALL BE AS	
SEEDING DATES		PERCENTAG
1/1 TO 5/1	ITALIAN RYE	33%
	KOREAN LESPEDEZA	33%
	SUMMER OATS	34%
5/1 10 7/15	SUDAN - SORGHUM	100%
5/1 TO 7/15	STAR MILLET	100%
7/15 TO 1/1	BALBOA RYE	67%
	ITALIAN RYE	33%
PERMANENT SEED	ING MIXTURES SHALL BE AS	
SEEDING DATES		PERCENTAGE
2/1 10 7/1	KENTUCKY 31 FESCUE	80%
	KOREAN LESPEDEZA	15%
	ENGLISH RYE	5%
6/1 10 8/15	KENTUCKY 31 FESCUE	55%
	ENGLISH RYE	20%
	KOREAN LESPEDEZA	15%
	GERMAN MILLET	10%
4/15 TO 8/15	BERMUDAGRASS (HULLED)	70%
	ANNUAL LESPEDEZA	30%
8/1 TO 12/1	KENTUCKY 31 FESCUE	70%
	ENGLISH RYE	20%
	WHITE CLOVER	10%
2/1 10 12/1	KENTUCKY 31 FESCUE	70%
	CROWN VETCH	25%
	ENGLISH RYE	5%

STORM PIPE INSTALLATION NOTES:

- STORM PIPE INSTALLATION NOTES:

 I. ASTALL STOM CASE POPIGIO, BY PERTAINACES TO MET THE MITTALLS, COMMONT, AND CONSTRUCTION MET AND CONSTRUCTION, AND CONSTRUCTION AND CONSTRUCTION STORMAND AND CONSTRUCTION AND C

SPECIAL EROSION CONTROL NOTES:

HILLSIDE PROTECTION AREA:

OUTSIDE OF HP OVERLAY: DISTURBED AREA = 0.85 AC. UNDISTURBED AREA = 1.21 AC. TOTAL SITE: DISTURBED AREA = 3.20 AC. UNDISTURBED AREA = 12.47 AC.

SPECIAL GRAVEL CONSTRUCTION NOTES:

- . ALL GRAVEL SHALL BE CLEAN STONE.

 GRAVEL PARKING AREAS SHALL BE CLEARLY DELINEATED.

 ALL GRAVEL AREAS REQUIRE FROMETER CONTAINMENT.

 GRAVEL PARKING LOTS SHALL INCLUDE GRID INSTALLATION, CONDETE FLUSH CURB, OR FLUSH LANDSCAPE TIMBERS TO PREVENT RUTTING.

LEGEND

(# C401)

NUMBER OF PARKING SPACE

ACCESSIBLE RAMP

----®^{CO}------RD---

PROPOSED STORM

STONE FILTER RING

TEMPORARY ROCK CHECK DAM

TEMPORARY ENHANCED ROCK CHECK DAM PROPOSED EROSION CONTROL BLANKET DISTURBED AREA LIMITS

DRAWAGE AREA

Ø

①

ð

 $\Pi\Pi\Pi$

0

*SW

10

-890 × 00.50

ASPHALT PWAT (LIGHT DUTY) ASPHALT PWMT (HEAVY DUTY)

===st=== EXISTING STORM SEWER LINE

-----SA-----

____×___

. **♦**.⊞.

₩ Ƴ FDC

9 γε/1

• C.O.

____E___

EXISTING WATER LINE EXISTING SANITARY SEWER LINE

EXISTING LOW PRESSURE LINE

EXISTING UNDERGROUND POWER

HORIZONTAL CONTROL POINT

REINFORCED CONCRETE PIPE

EXISTING FENCE

EXISTING ELECTRIC LINE

EXISTING CATCH BASIN

SMALL ROUND DRAIN

EXISTING POWER POLE

EXISTING GUY ANCHOR

EXISTING FIRE HYDRAN EXISTING GAS METER EXISTING GAS VALVE

FYISTING WATER METER

EXISTING WATER MANHOLE EXISTING POWER MANHOLE EXISTING TELEPHONE MANHOLI PROPOSED AIR RELEASE VALVE

POST INDICATOR VALVE PROPOSED WATER VALVE

PROPOSED FLUSH CONNECTION

PROPOSED SANITARY MANHOLE

PROPOSED SAN. CLEAN OUT

PROPOSED WATER METER

PROPOSED STORM SEWER LINE

PROPOSED CAS LINE PROPOSED LOW PRESSURE SEWER

PROPOSED F/ONE CRIMOER PLIMP

PROPOSED SANITARY SEWER LINE

PROPOSED WATER BLOWOFF VALVE

EXISTING WATER VALVE

FYISTING GAS LIME

EXISTING TREE

DETAIL REFERENCE (DETAIL NO./SHEET NO.)

COORDINATE POINT ACCESSIBLE PARKING

EXISTING CONTOUR
PROPOSED FOOT ELEVATIONS:
(PTE) PRINCE ELEVATIONS:
(PTE) PRINCE ELEVATIONS:
(PTE) PRINCE ELEV
(TIC) THE BLACK CURB
(BIG) BOTTOM OF CURB
(BIG) SOCIEMUX
(TIC) THE OF STEP
(BOX) BOTTOM OF SPEL
(BOX) BOTTOM OF BMLL

PROPOSED STORM CLEANOUT (SEE DETAIL) PROPOSED ROOF DRAIN PROPOSED UNDERDRAIN

PROPOSED STORM STRUCTURE DIVERSION BERM

TEMP. INLET PROTECTION (TYPE I) TEMP. INLET PROTECTION (TYPE II)

======

DISTORAGE AREA LIMITS
DRAINAGE AREA
TEMPORARY SILT FENCE
TEMPORARY SILT FENCE WITH BACKING
TEMPORARY SEDMENT TUBE
TEMPORARY EROSION EEL TEMPORARY EROSON EEL
FLOODBAN
100-YR FLOODPLAN
500-YR FLOODPLAN
NO-TRL LINE
FEMA ZONE A
RPARIAN BUFFER ZONE
SNIKHOLE BUFFER
HALLSDE PROTECTION AREA

NO. SPECIAL USE

SUBMITTAL 3-E-25-SU

CAMPGROUND DROP





865.670.8555 PIER GROUP
PARTNERS IN EVERYTHING
RECREATION
121 E. JACKSON AVENUE
KNOXVILLE, TENNESSEE 37915


CCI PROJ. NO. JANUARY 24, 2025


AND LEGENDS


C002

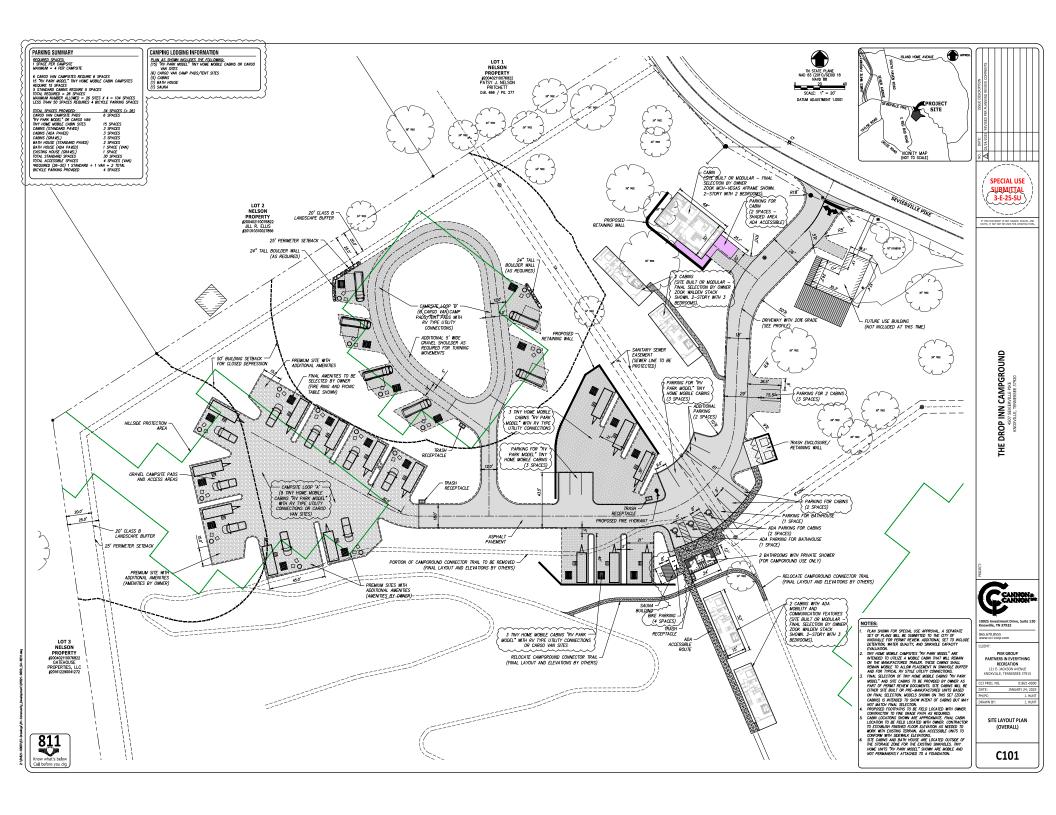

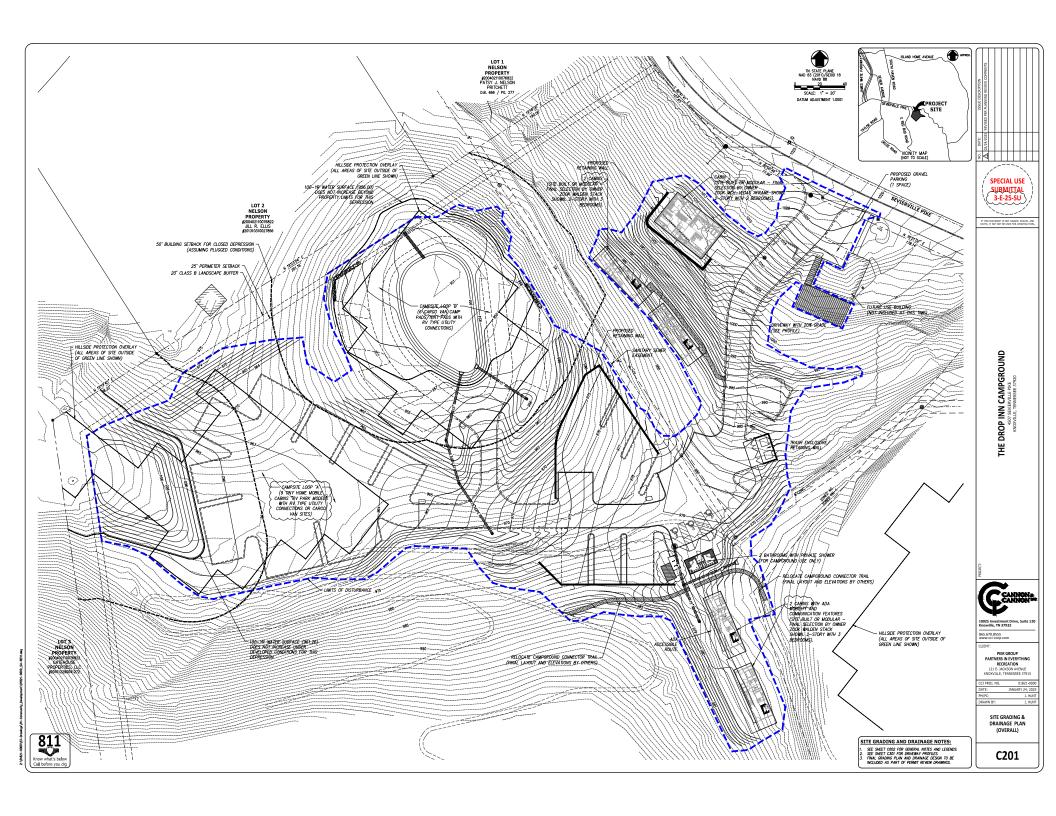

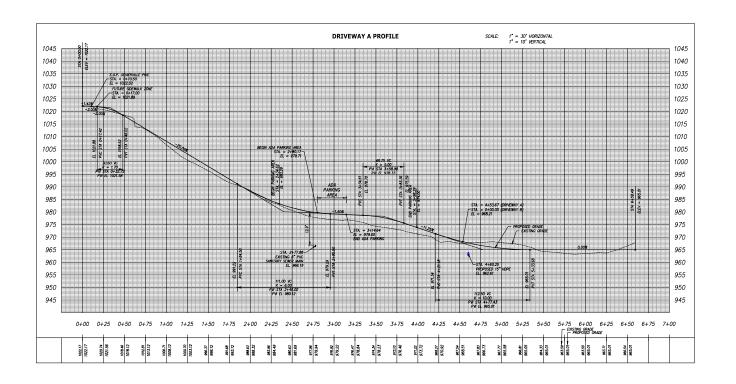

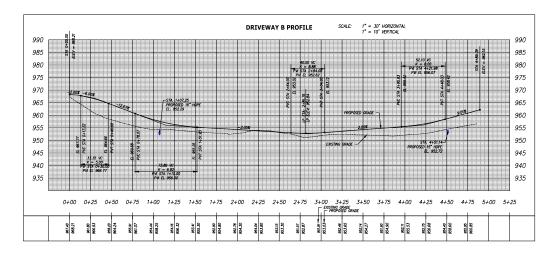

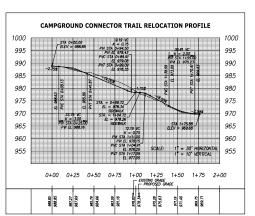

SPECIAL NOTE:

1. PROPUE SHOWN FOR CAMPOROUND CONNECTOR BINE TRAIL

15 FOR INTORIATIONAL PURPOSES ONLY. OWNER AND

CONTRACTOR TO FELD LOCATE TRAIL AS REQUIRED TO

COORDINAL WITH EASTING CAMES AND PROPOSED

GRADES SHOWN AS NEEDED TO PROVIDE A SUITABLE BINE
TRAIL.

SPECIAL USE SUBMITTAL 3-E-25-SU

TED, ET MAY NOT BE USED FOR CONSTRUC

THE DROP INN CAMPGROUND
4507 SEVIENULE PIKE
KNOXVILLE, TENNESSEE 37920

CANINON

10025 Investment Drive, Suite 12 Knoxville, TN 37932


865.670.8555 www.cci-corp.com

PIER GROUP
PARTNERS IN EVERYTHING
RECREATION
121 E. JACKSON AVENUE
KNOXVILLE, TENNESSEE 37915

CCI PRDJ. ND. 01821-0000
DATE: JANUARY 24, 2025
PM/PC: J. HUNT
DRAWN BY: J. HUNT

DRIVEWAY PROFILES

C205

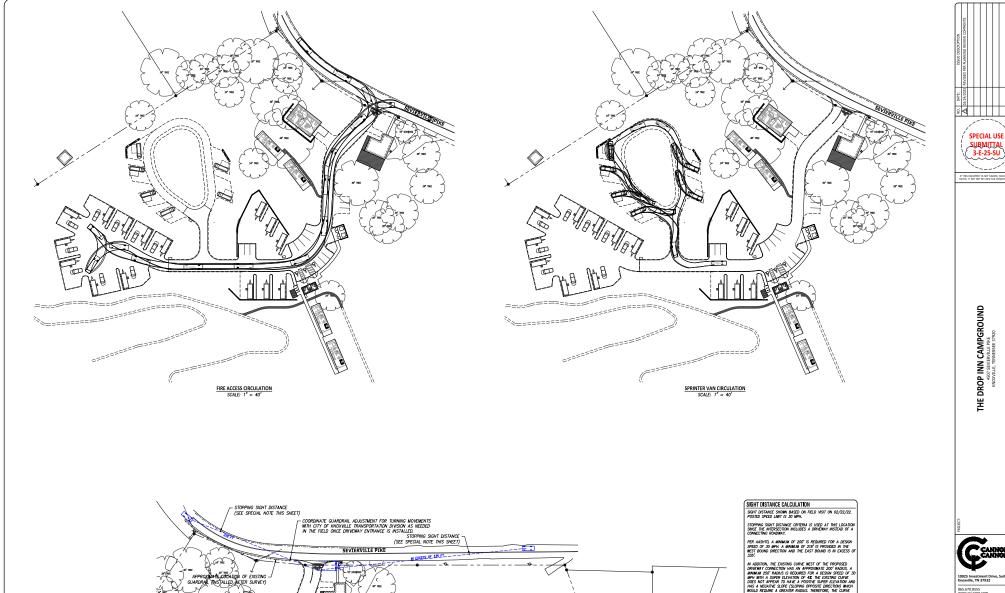


865.670.8555


PIER GROUP
PARTNERS IN EVERYTHING
RECREATION
121 E. JACKSON AVENUE
KNOXVILLE, TENNESSEE 37915

TURNING MOVEMENTS & SIGHT DISTANCE

C401

811

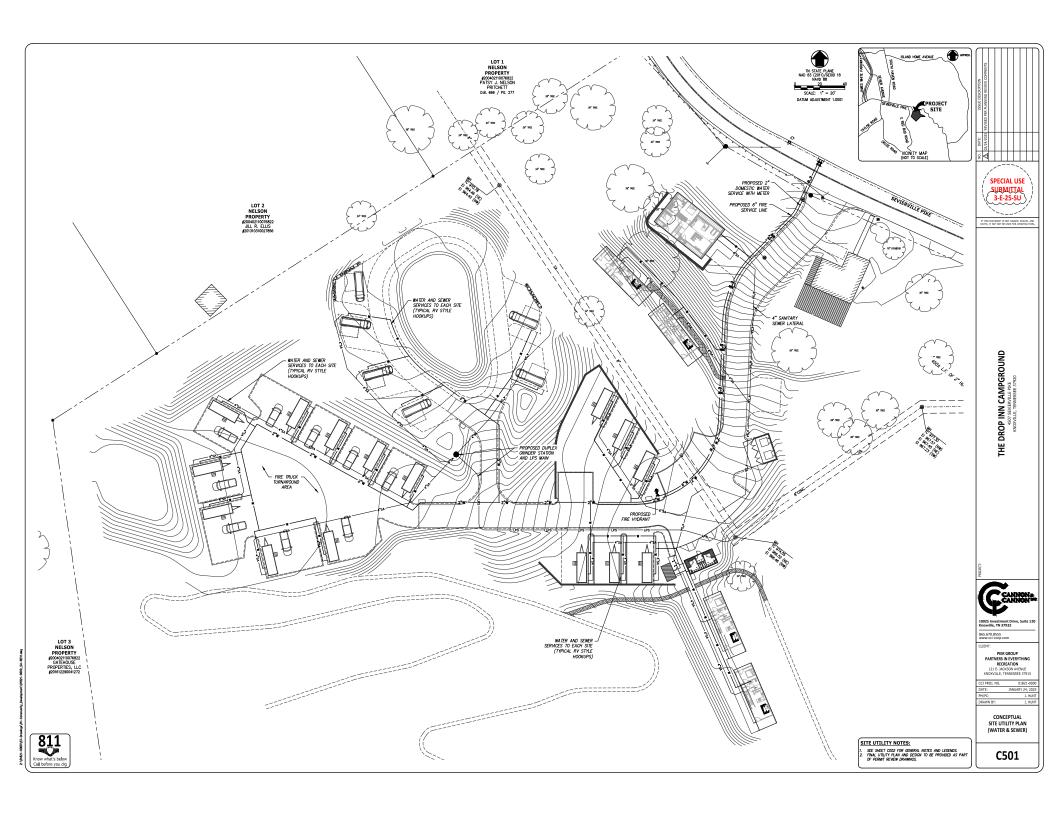

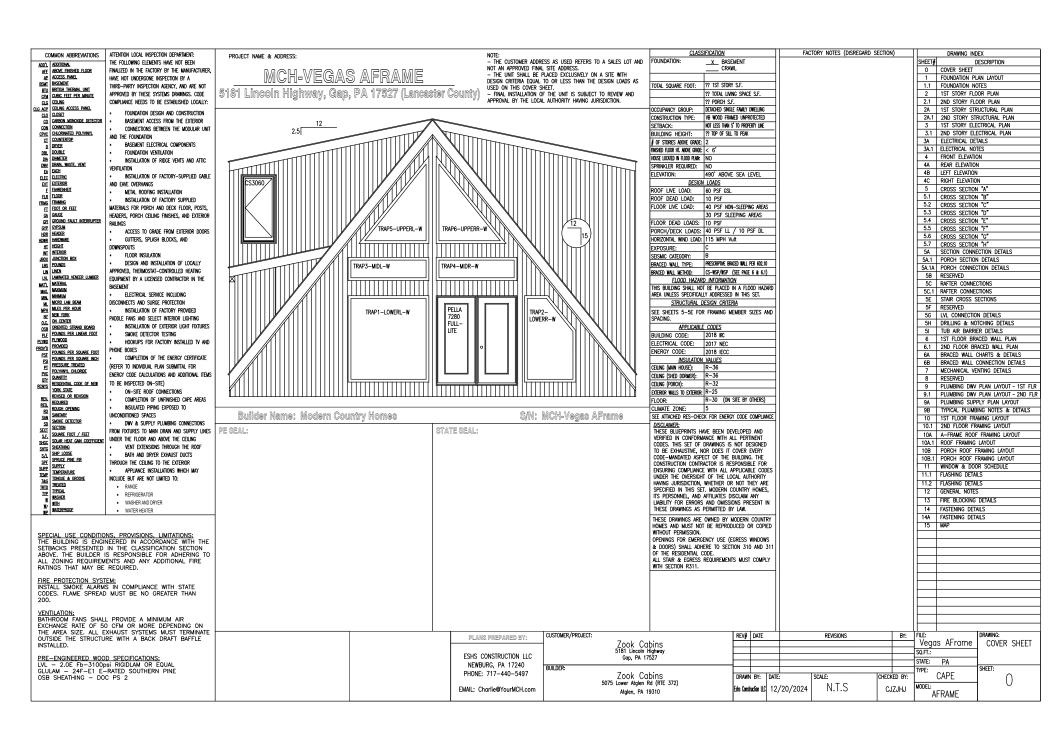

FOUNDATION MUST BE DESIGNED BY A QUALIFIED DESIGN PROFESSIONAL WITH EXPERTISE IN LOCAL SOIL CONDITIONS. THIS SAMPLE PLAN IS INTENDED SOLELY TO PROVIDE DIMENSIONAL AND LOADING DATA TO THE DESIGN PROFESSIONAL TO ENSURE THEIR FOUNDATION DESIGN IS ALIGNED WITH THE REQUIREMENTS OF THE MODULAR BUILDING.

THE MANUFACTURER DISCLAIMS ANY LIABILITY FOR ERRORS IN FOUNDATION CONSTRUCTION. ALL DIMENSIONS MUST BE VERIFIED AND CONFIRMED AGAINST THE FLOOR PLAN BY THE BUILDER/DEALER PRIOR TO FOUNDATION CONSTRUCTION. THE BUILDER/DEALER IS REQUIRED TO CONTACT THE MANUFACTURER WITH ANY DISCREPANCIES BEFORE COMMENCING CONSTRUCTION.


DESIGN LOADS PROVIDED APPLY ONLY TO THE FACTORY—MANUFACTURED PORTIONS OF THE BUILDING. ANY MODIFICATIONS OR ADJUSTMENTS TO THESE PLANS TO ACCOMMODATE SITE—MANUFACTURED STRUCTURES ARE THE RESPONSIBILITY OF THE DESIGN PROFESSIONAL HANDLING THE SITE—MANUFACTURED SEGMENT.

PA MODULAR EXEMPTION NOTES:
THE MANUFACTURER CONFIRMS THAT THE
STRUCTURE (MCH-VEGAS RFAME) DOES
NOT QUALIFY AS A MANUFACTURED HOME
UNDER THE NATIONAL MANUFACTURED

HOUSING CONSTRUCTION AND SAFETY STANDARDS ACT AND IS:

1. INTENDED EXCLUSIVELY FOR ERECTION OR INSTALLATION ON A SITE-BUILT PERMANENT FOUNDATION.

- 2. NOT INTENDED TO BE MOVED AFTER ERECTION OR INSTALLATION.
- 3. ENGINEERED AND MANUFACTURED IN COMPLIANCE WITH THE 2015 IRC.
- 4. TO THE MANUFACTURERS KNOWLEDGE, THE STRUCTURE IS MEANT ONLY FOR USE ON A SITE-BUILT PERMANENT FOUNDATION.

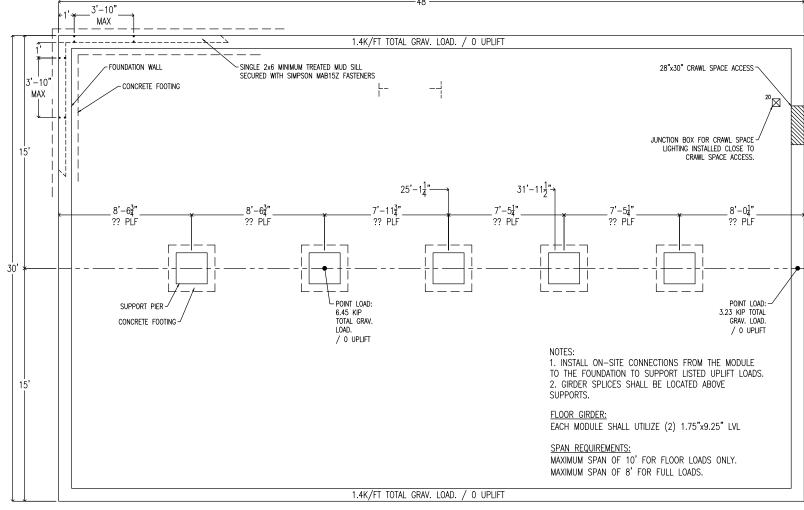


PA FOUNDATIONS MUST SATISFY THE FOLLOWING REQUIREMENTS:


A ACCURATELY REFLECT THE BUILDING'S TRUE FOOTPRINT AND BE SPECIFIC TO THE PARTICULAR UNIT.


 \bowtie

- B PROVIDE SUPPORT COLUMNS FOR ALL LOADS OVERHANGING OPENINGS EXCEEDING 4 FT. IF A SUPPORT COLUMN IS ABSENT, ONE MUST BE INSTALLED.
- C WHEN FILL EXCEEDS 5 FT, UTILIZE 12" BLOCKS ON 20"x10" CONCRETE FOOTINGS.
- D ENSURE FOUNDATION DRAINAGE AND DAMP PROOFING ARE IN COMPLIANCE WITH CODE REQUIREMENTS.
- E ALL ELECTRICAL AND MECHANICAL INSTALLATIONS MUST ADHERE TO CURRENT STATE AND LOCAL CODE REQUIATIONS. F INSULATION FOR BASEMENT WALLS OR CRILINGS MAY BE DETAILED ON FOUNDATION PLANS TO MEET ENERGY REQUIREMENTS AS PER 2015 IECC.
- G PROVIDE A MINIMUM OF 6" FROM THE BOTTOM OF GRADE TO THE SIDING AT THE SITE.
- H THE PURCHASER IS RESPONSIBLE FOR ALL SERVICE ENTRY CONNECTIONS AND ON-SITE TESTING AS REQUIRED BY THE LOCAL JURISDICTION.
- I FOUNDATION PLANS MAY REQUIRE SEALING BY A LICENSED ENGINEER IF MANDATED BY THE LOCAL JURISDICTION.
- J BACKFILLING AND TAMPING MUST BE PERFORMED IN ACCORDANCE WITH THE LOCAL BUILDING OFFICIAL'S GUIDELINES.


PLANS PREPARED BY:		REV#	DATE		REVISIONS	В		LE: Vegas AFrame	DRAWING: FOUNDATION
ESHS CONSTRUCTION LLC	Zook Cabins 5181 Lincoln Highway Gap, PA 17527						SQ	Q.FT.:	PLAN LAYOUT
NEWBURG, PA 17240 PHONE: 717-440-5497		DRAWN	BY: I	DATE:	SCALE:	CHECKED E	TY	TATE: PA PPE: CAPE	SHEET:
EMAIL: Charlie@YourMCH.com	5075 Lower Atglen Rd (RTE 372) Atglen, PA 19310	Eshs Const	nuction LLC	12/20/2024	1/4"=1'-0"	CJZJH	J MC	ODEL: AFRAME	

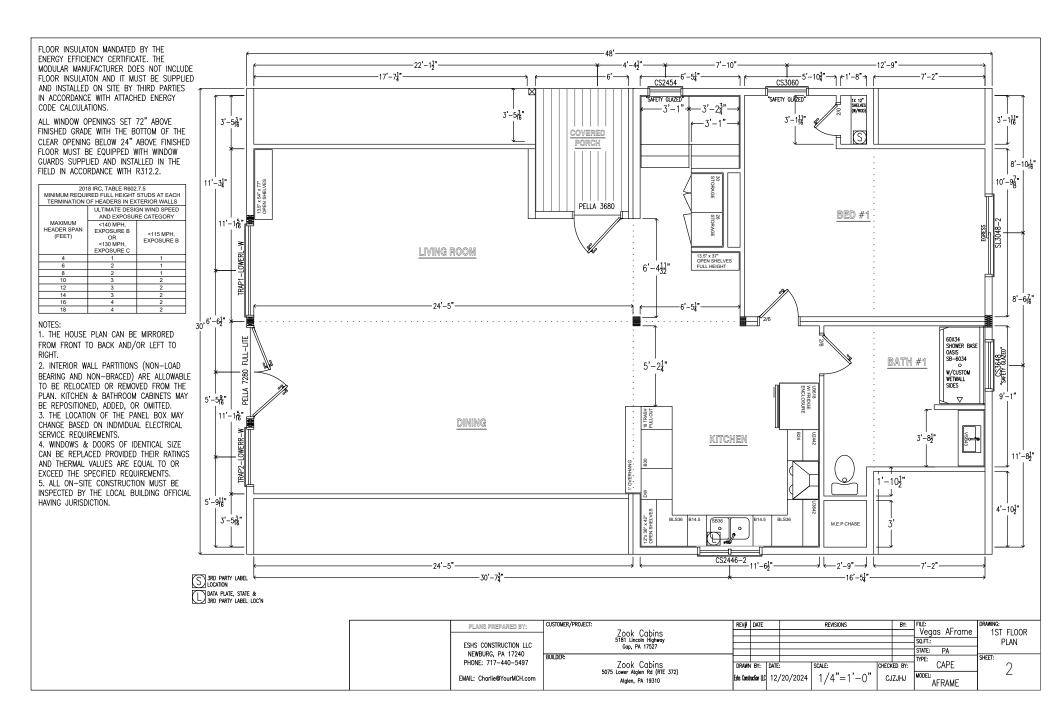

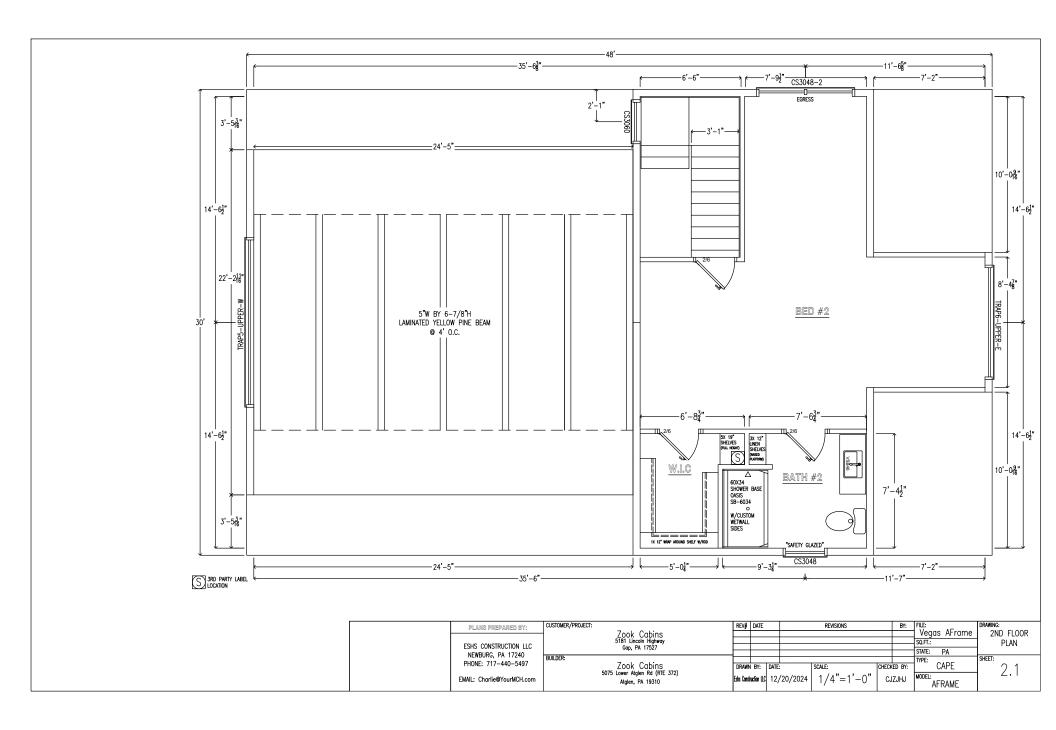


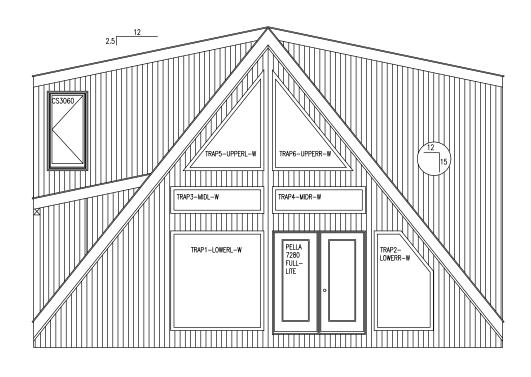


	PLANS PREPARED BY:	CUSTOMER/PROJECT:	REV#	DATE		REVISIONS	BY:		DRAWING:
		Zook Cabins 5181 Lincoln Highway						Vegas AFrame	FRONT
	ESHS CONSTRUCTION LLC	5181 Lincoln Highway	<u> </u>	-	_		_	SQ.FT.:	ELEVATION
	NEWBURG DA 17040	Gap, PA 17527			_		_	STATE: PA	
		BUILDER:							SHEET:
	PHONE: 717-440-5497	Zook Cabins	DRAWN	N BY: D	ATE:	SCALE:	CHECKED BY:	CAPE	1 / 1
	EMAIL: Charlie@YourMCH.com	5075 Lower Atglen Rd (RTE 372)	Fshs Const	loction IIC	12/20/2024	1/4"=1'-0"	CJZJHJ	MODEL:	1 7
		Atglen, PA 19310			,,	1/ 1 -1 0	5520110	AFRAME	

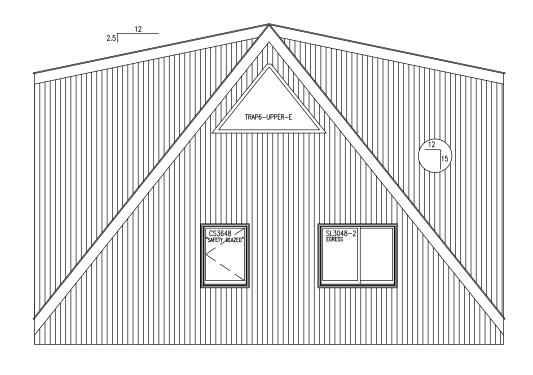

Γ	PLANS PREPARED BY:	CUSTOMER/PROJECT:	REV#	DATE		REVISIONS	BY		DRAWING:
	ESHS CONSTRUCTION LLC	Zook Cabins 5181 Lincoln Highway						Vegas AFrai	me REAR ELEVATION
	NEWBURG, PA 17240	Gap, PA 17527						STATE: PA	SHEET:
	PHONE: 717-440-5497	Zook Cabins 5075 Lower Atglen Rd (RTE 372)	DRAWN	BY: D	ATE:		CHECKED BY	: CAPE	— — 4A ∣
	EMAIL: Charlie@YourMCH.com	Atglen, PA 19310	Eshs Const	nuction LLC	12/20/2024	1/4"=1'-0"	CJZJHJ	MODEL: AFRAME	

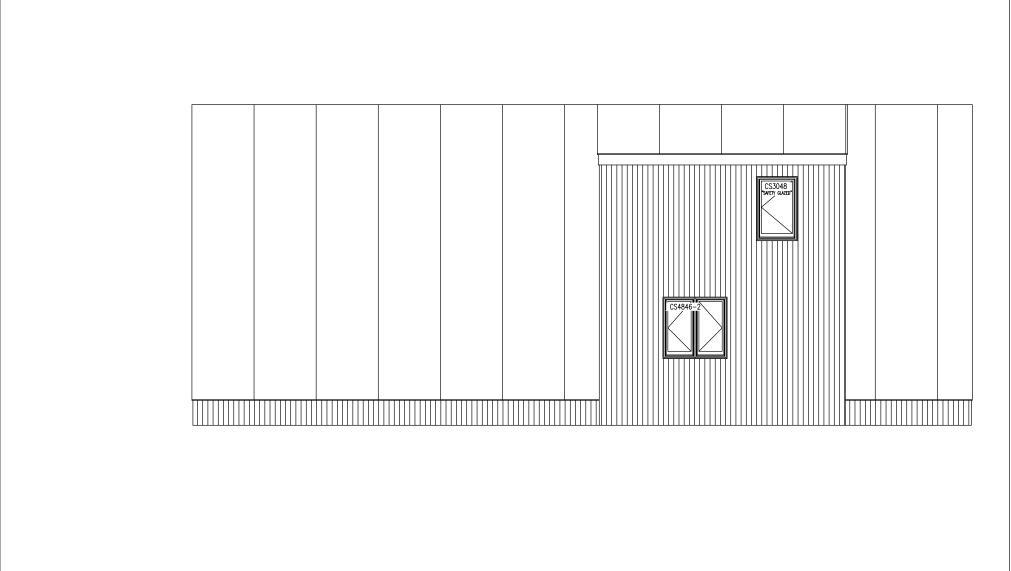

PLANS PRI	PARED BY:		REV#	DATE		REVISIONS	BY:	FILE: Vegas AFrame	DRAWING:
ESHS CONST NEWBURG,	RUCTION LLC	Zook Cabins 5181 Lincoln Highway Gap, PA 17527						SQ.FT.: STATE: PA	LEFT ELEVATION
PHONE: 717		5075 Lower Atolen Pd (PTF 372)		BY: DATE	: /20/2024		CHECKED BY:		SHEET: 4B

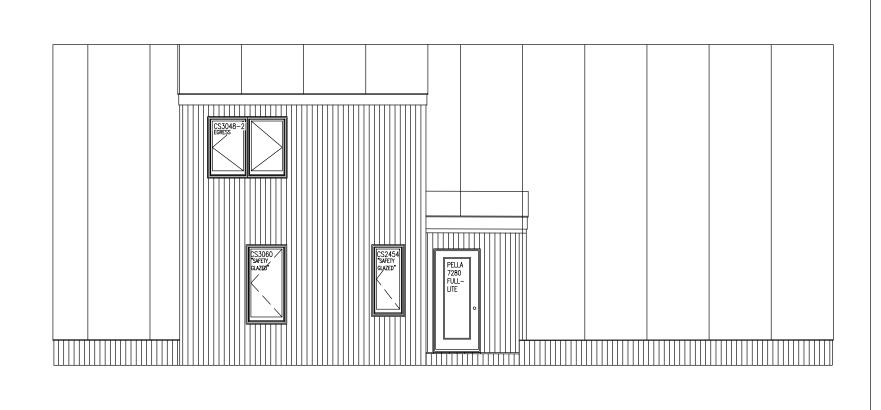

PLANS PREPARED BY	CUSTOMER/PROJECT:	REV#	DATE		REVISIONS	BY:	FILE:	DRAWING:
	Zook Cabins 5181 Lincoln Highway						Vegas AFrame	RIGHT
ESHS CONSTRUCTION L	5181 Lincoln Highway	\vdash		_		_	SQ.FT.:	ELAVATION
NEWBURG, PA 17240		\vdash					STATE: PA	1
PHONE: 717–440–549	BUILDER:						TYPE:	SHEET:
PHUNE: /1/-440-349	Zook Cabins	DRAWN	BY: D	ATE:	SCALE:	CHECKED BY:	CAPE	
EMAIL: Charlie@YourMCH.	5075 Lower Atglen Rd (RTE 372)	Felic Coneti	urina IIC 1	2/20/2024	1/4"=1'-0"	CJZJHJ	MODEL:	46
EMAIL: CIIdrile Tourmon.	Atglen, PA 19310	Lana COIDE	want div	2/20/2024	1/4-1-0	COZUNO	AFRAME	








THESE PLANS HAVE BEEN EXTRACTED FROM APPROVED BUILDING SYSTEMS FILED WITH THE STATE.

PA CERTIFICATION FOR MODULARS
YES X. NO

145.33. MANUFACTURED HOMES EXCLUDED.
(a) MANUFACTURED HOMES WHICH ARE SUBJECT TO SECTIONS
(604 AND 625 OF THE NATIONAL MANUFACTURED HOUSING
CONSTRUCTION AND SAFETY STANDARDS ACT DF 1974 (42
U.S.CA. 5403 AND 5424) AND REGULATIONS ISSUED THEREUNDER
BY THE UNITED STATES DEPARTMENT DF HOUSING AND URBAN
DEVELOPMENT ARE NOT SUBJECT TO THIS CHAPTER.
(b) THE FOLLOWING LANGUAGE MUST APPEAR IN THE
INSTALLATION DOCUMENTATION PROVIDED WITH THE
INDUSTRIALIZED HOME AND THE DATA PLATE:

THE MANUFACTURER CERTIFIES THAT THE STRUCTURE (GN-18156) IS NOT A MANUFACTURED HOUSE SUBJECT TO THE PROVISIONS OF THE NATIONAL MANUFACTURED HOUSING CONSTRUCTION AND SAFETY STANDARD ACT AND IS: 1) DESIGNED DINLY FOR ERECTION OR INSTALLATION ON A SITE BUILT PERMANENT FOUNDATION 2) NOT DESIGNED TO BE MIGVED DINCE SO ERECTED OR INSTALLED 3) DESIGNED AND MANUFACTURED TO COMPLY VITH NATIONALLY RECOGNIZED MODEL BUILDING CODE OR EQUIVALENT TO BUILDING CODES FOR ON-SITE HOUSING, OR VITH THE MINIMUM PROPERTY STANDARDS ADAPTED BY THE SECRETARY PURSUANT TO TITLE II OF THE NATIONAL HOUSING ACT, AND 4) TO THE MANUFACTURER'S KNOWLEDGE NOT INTERDED TO BE USED DTHER THAN DN A SITE-BUILT PERMANENT FOUNDATION

QN-18156/JN-85197/PA

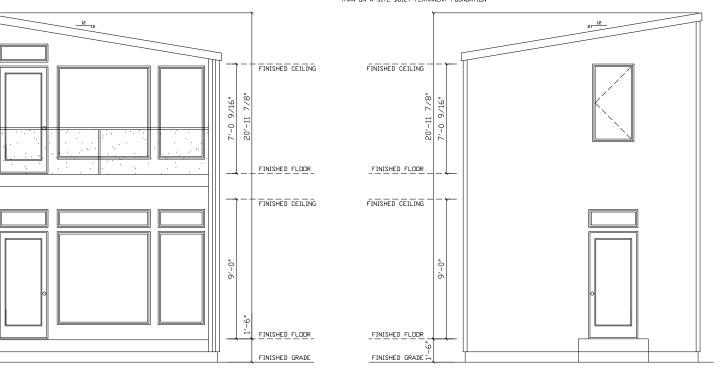

FRONT ELEVATION

DMIT SIDING AND SHINGLES

REAR ELEVATION

THESE DRAWINGS HAVE BEEN DEVELOPED SPECIFICALLY FOR THE HOMEDWNER FROM APPROVED BUILDING SYSTEMS. PLEASE CHECK LAYDUT, RODM SIZE, VINDOV LOCATION, KITCHEN, CEILING HEIGHT, RODF PITCH AND WALL SIZE TO BE CERTAIN THEY ARE WHAT YOU WANT. IF THERE ARE ANY CHANGES, PLEASE MAKE YOUR CHANGES AND HIGHLIGHT THEM AND RETURN TO BUILDER FOR REVISIONS BY US.

ALL PRODUCTS ARE BUILT ACCORDING TO STATE MANDATED CODES, HOWEVER IT IS THE RESPONSIBILITY OF THE LOCAL BUILDER TO BRING TO DURA ATTENTION ANY SPECIAL ISSUES SUCH AS, RADON VENTS AND ANY STRUCTURAL LOADS IN EXCESS OF THE STATE MANDATED CODES.

NOTE: ACTUAL HOUSE MAY VARY FROM ELEVATION



PA,

M 2-STORY ELEVATIONS

CUSTOM FRONT/REAR

1540 N□NS


- ADDRESS* ER, PA


SHDE

S

CABIN'

ZDDK

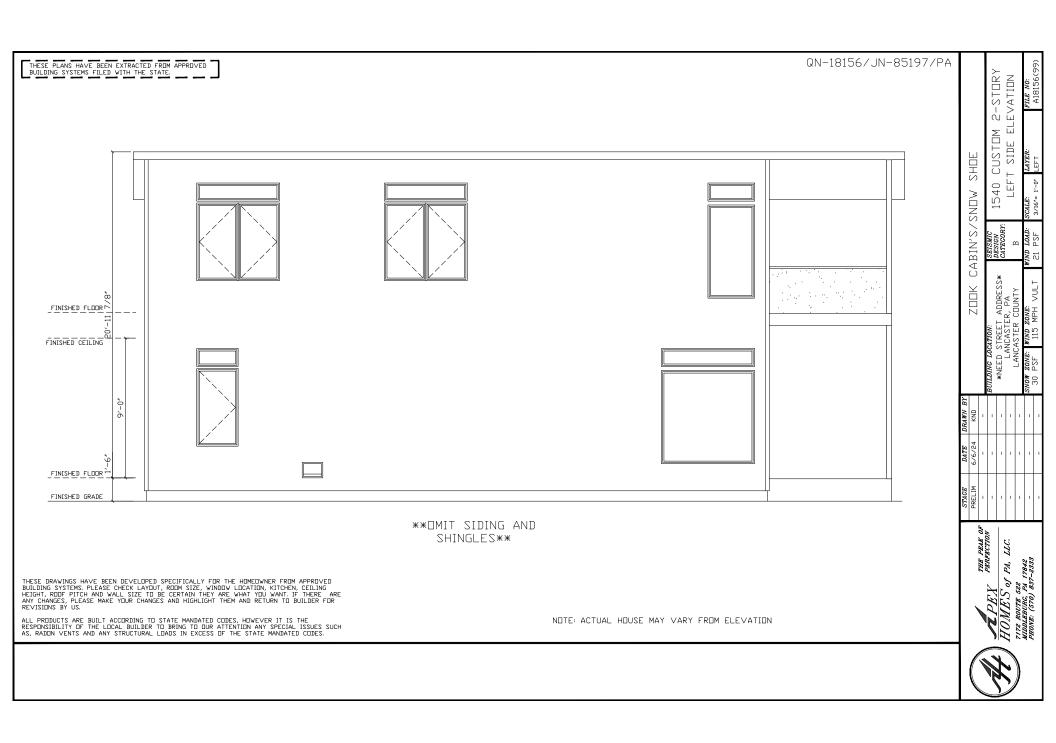

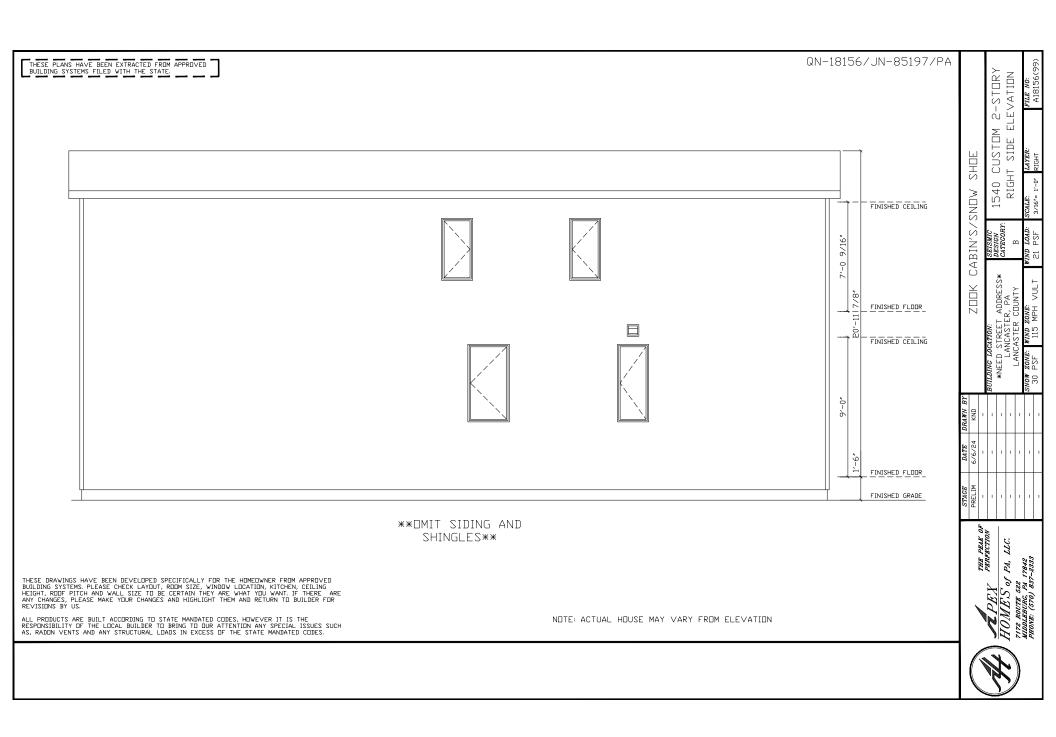

QN-18156/JN-85197/PA THESE PLANS HAVE BEEN EXTRACTED FROM APPROVED BUILDING SYSTEMS FILED WITH THE STATE. NOTE 2-STORY OOR PLAN 1ST FLOOR WINDOW HEADERS TO BE @ 100" ASF PENNSYLVANIA CODES 2018 INTERNATIONAL RESIDENTIAL CODE 2017 NATIONAL ELECTRICAL CODE 2018 INTERNATIONAL ENERGY CONSERVATION CODE (EXCEPT WHERE NOTED) CUSTOM GLENCO SYSTEM CALC'S: ALL EXT. LDAD BEARING HDR'S: WITH SPAN DF ?'-?' DR LESS WILL BE (3) 2x6 SPF #2 ALL DTHERS WILL BE SPECIFIED. ALL REQUIRED JACK STUDS STORY SHDE SHOWN ARE 2x6 SPF #2. 1540 1ST21'-9 5/8" HDR @ N□NS 12'-6" HDR @ 48'-0" 102 1/2" ASF -3' RADON VENT (SP) VSP) SAFETY GLAZED C2050 S 8'-2" **₩**₩7′-11 *1*72″ W2424 (ND D00R) W2424 (ND D0DR) BIN щ T3012 DOUBLE PLATE 2¹-6 1/4° BBC45 35 P3060 SAFETY GLAZED \subseteq <u></u>===== 9'-3 1/4" 12'-8 1/4" \bigcirc DVER# W1830 HDUSE** BATH #3 ZDDK ADDRES KITCHEN 2′~10" 9-2×10 TREATED PORCH FLOOR 5/4" DECKING BY APEX HOM ķ (SP) BEDROOM #3 DINING/LIVING ROOM DWS 15'-0' UNIT T6012 P6060 SAFETY GLAZED \mathbb{H} Ι T3012 DOUBLE PLATE 8'-6 -3' DRAIN & SP 30611 Ī'n 2-3/4" SUPP RONT HALL FROM 2nd STORY SLIDED WALL RATI ING ** DINSITE (SP) GLASS *SLOPED AREA* DTHERS 5 SP 30611 B24 BD12 CUSTOM 33" OPEN BASE CAB B24 B24 ú WALL HUNG 12'-8 1/4" WOH W2454B **XXX** LCABINETS UNDER STAIRS ∕(SP) (SP) 8'-0" T2812 SINGLE PLATE P6060 4 SAFETY GLAZED SP c2850 PELLA IMPERVIA WINDOWS 4'-7" WINDOW LABEL ROUGH OPENING 24" × 48" THE PEAK OF PERFECTION 2050 24" × 60" ₩₩ 4"X10" FLOOR REGISTER (3" FROM WALL) 5 REQUIRED 32" × 14" 2812 TDE-KICK HEAT GRILLE (LDCATED @ WET AREAS) 1 REQUIRED

G'X14" HIGH/LDW AIR RETURNS @ 87" & 18" AFF. 2 PAIRS REQUIRED 32" × 60" 2850 3012 36" × 14" PA, 3050 36" × 60" THESE DRAWINGS HAVE BEEN DEVELOPED SPECIFICALLY FOR THE HOMEOWNER FROM APPROVED BUILDING SYSTEMS. PLEASE CHECK LAYDUT, RODM SIZE, WINDOW LOCATION, KITCHEN, CEILING HEIGHT, RODE PITCH AND WALL SIZE TO BE CERTAIN THEY ARE WHAT YUU WANT. IF THERE ARN CHANGES, PLEASE MAKE YOUR CHANGES AND HIGHLIGHT THEM AND RETURN TO BUILDER FOR REVISIONS BY US. 6 3060 36" × 72" 5412 64" × 14" 2850-2 64" × 60" 6012 72" × 14" ALL PRODUCTS ARE BUILT ACCORDING TO STATE MANDATED CODES, HOWEVER IT IS THE RESPONSIBILITY OF THE LOCAL BUILDER TO BRING TO DURA ATTENTION ANY SPECIAL ISSUES SUCH AS, RADON VENTS AND ANY STRUCTURAL LOADS IN EXCESS OF THE STATE MANDATED CODES. 6060 72" × 72" NOTES:

5. 9'-0" 1ST FLOOR CEILING HEIGHT

8.

9.


1. BUILDER IS RESPONSIBLE FOR PROVIDING A PROPERLY SIZED HEATING SYSTEM TO COVER A ? BTU LOSS

3. PELLA IMPERVIA WINDOWS

1ST FLOOR SQUARE FOOTAGE = 600 SQ/FT

HEAT LOSS WAS CALCULATED WITH R-?? FLOOR INSULATION

QN-18156/JN-85197/PA THESE PLANS HAVE BEEN EXTRACTED FROM APPROVED BUILDING SYSTEMS FILED WITH THE STATE. 2-STORY ODR PLAN GLENCO SYSTEM CALC'S: ALL EXT. LOAD BEARING HDR'S: WITH SPAN OF ?'-?' DR LESS WILL BE (3) 2x6 SPF #2 ALL DTHERS WILL BE SPECIFIED. ALL REQUIRED JACK STUDS .00R SHOWN ARE 2x6 SPF #2. CUSTOM STORY FL SHDE 48'-0" VAULTED 1540 2ND 5'-7" HDR @ 72" ASF SAFETY SP GUAZED C2040 HDR P N□NS SP ASF −3' RADON VENT SAFETY SP GLAZED C20#0 S 10'-0" 10'-6 1/2" 8'-6txxx RXXX8'-E CABIN' **TRIM WILL
BE CUT WITH ROOF ANGLE HDUSE** T ADDRESS* ER, PA BATH #2 ZDDK

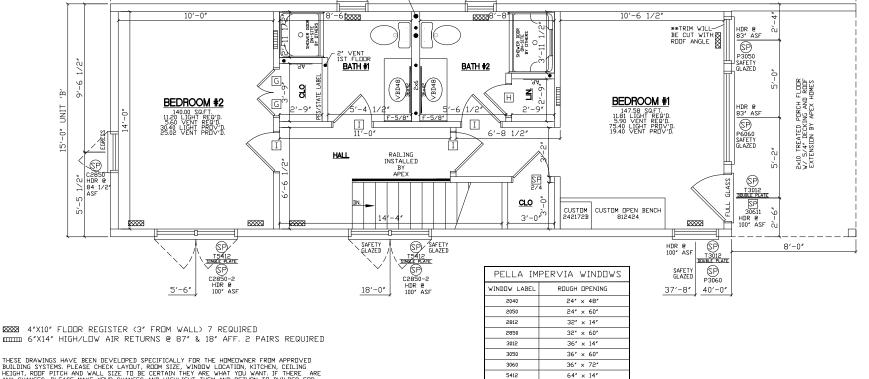

2850-2

6012

6060

64" × 60"

72" × 14"

72" × 72"

₩ 4"X10" FLOOR REGISTER (3" FROM WALL) 7 REQUIRED

THESE DRAWINGS HAVE BEEN DEVELOPED SPECIFICALLY FOR THE HOMEOWNER FROM APPROVED BUILDING SYSTEMS. PLEASE CHECK LAYDUT, RODM SIZE, WINDOW LOCATION, KITCHEN, CEILING HEIGHT, RODF PITCH AND WALL SIZE TO BE CERTAIN THEY ARE WHAT YOU WANT. IF THERE ARIANY CHANGES, PLEASE MAKE YOUR CHANGES AND HIGHLIGHT THEM AND RETURN TO BUILDER FOR REVISIONS BY US.

ALL PRODUCTS ARE BUILT ACCORDING TO STATE MANDATED CODES, HOWEVER IT IS THE RESPONSIBILITY OF THE LOCAL BUILDER TO BRING TO OUR ATTENTION ANY SPECIAL ISSUES SUCH

AS, RADUN VENTS AND ANY STRUCTURAL LUADS IN EXCESS OF THE STATE MANDATED CODES.	
NOTES: 1. PELLA IMPERVIA 2. 2ND FLOOR SQUARE FOOTAGE = 600 SQ/FT 3. APPROX. 7'-0"/9'-4" 2ND FLOOR CEILING HEIGHT 4. 2/12 NON STORAGE RAFTER ROOF SYSTEM @ 16" D.C.	6. 7. 8. 9. 10.



THE PEAK OF PERFECTION

PA,

5

+

RONT

**

AREA, OR SIMILAR ROOMS OR AREAS SHALL BE PROTECTED BY A LISTED COMBINATION-TYPE ARC-FAULT CIRCUIT INTERRUPTER INSTALLED TO PROVIDE

RECEPTACLES AND ALL RECEPTACLES SERVING KITCHEN COUNTERTOPS, THE

DISHWASHER CIRCUIT OR RECEPTACLES THAT ARE WITH IN 6'-0" OF THE DUTSIDE EDGE OF THE KITCHEN SINK INCLUDING RECEPTACLES UNDER THE

9. ALL BATHROOM RECEPTACLES, LAUNDRY RECEPTACLES, EXTERIOR

SINK OR IN CABINETS ARE REQUIRED TO BE GFI PROTECTED.

PROTECTION OF THE ENTIRE BRANCH CIRCUIT.

THESE DRAWINGS HAVE BEEN DEVELOPED SPECIFICALLY FOR THE HOMEOWNER FROM APPROVED INDEX DIAMATINGS AND ELEASE CHECK LAYDUT, RODM SIZE, VINDOW LIBCATION, KITCHEN, CELLING BUILDING SYSTEMS. PLEASE CHECK LAYDUT, RODM SIZE, VINDOW LIBCATION, KITCHEN, CELLING HEIGHT, RODF PITCH AND WALL SIZE TO BE CERTAIN THEY ARE WHAT YOU WANT. IF THERE AR ANY CHANGES, PLEASE MAKE YOUR CHANGES AND HIGHLIGHT THEM AND RETURN TO BUILDER FOR

ALL PRODUCTS ARE BUILT ACCORDING TO STATE MANDATED CODES, HOWEVER IT IS THE EESPONSIBILITY OF THE LOCAL BUILDER TO BRING TO DUR ATTENTION ANY SPECIAL ISSUES SUCH AS, RADON VENTS AND ANY STRUCTURAL LDADS IN EXCESS OF THE STATE MANDATED CODES.



LLC.

S

7842 PA,

522 522 1983;












12X24:288 SF RVIA SEAL, BUILT TO THE ANSI 119.5 STANDARDS

	INDEX OF SHEEETS
001	FLOOR PLAN
002	JOIST FRAMING
003	FRAMING PLAN
100	DRIVER: FRAMING & EXTERIOR
101	PASSENGER: FRAMING & EXTERIOR
102	HITCH: FRAMING & EXTERIOR
103	REAR: FRAMING & EXTERIOR
200	ELECTRICAL
201	PLUMBING

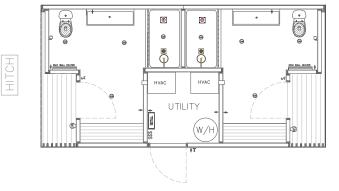

Any unauthorised use, reproduction, or distribution of these plans, whether in whole or in part, is expressly prohibited without prior written consent.

ZOOK CABINS 5075 Lower Valley Rd. Suite B Atglen, PA 19310 USA

Zek

SCALE: $\frac{1}{4}$ " = 1'0" DRAWN BY: DW

ISSUED: 3.20.24

REVISED:


12x24

BATH HOUSE FLOOR PLAN

 $\bigcirc\bigcirc\bigcirc$

COPYRIGHT 2024



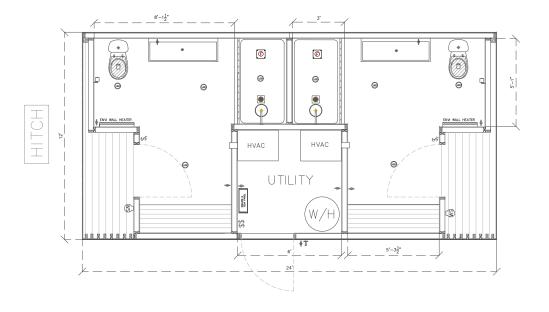

ZOOK CABINS 5075 Lower Valley Rd. Suite B Atglen, PA 19310 USA



SCALE: $\frac{1}{4}$ " = 1'0"

DRAWN BY: DW

ISSUED: 3.20.24

REVISED:

12×24 BATH HOUSE


FLOOR PLAN

001

Any unauthorised use, reproduction, or distribution of these plans, whether in whole or in part, is expressly prohibited without prior written consent.

COPYRIGHT 2024



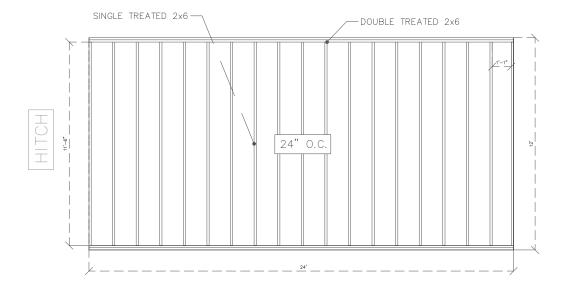



SCALE: $\frac{1}{4}$ " = 1'0"

DRAWN BY: DW

ISSUED: 3.20.24

REVISED:

12×24

BATH HOUSE


FLOOR JOIST PLAN

Any unauthorised use, reproduction, or distribution of these plans, whether in whole or in part, is expressly prohibited without prior written consent.

COPYRIGHT 2024





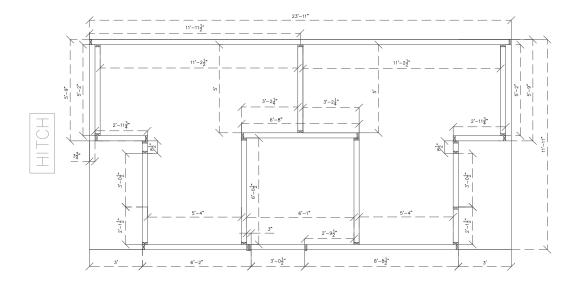



Suite

/ Rd. USA

Valley 19310 L

Lower , PA

ZOOK C 5075 Ld Atglen,

CABINS

SCALE: $\frac{1}{4}$ " = 1'0"

DRAWN BY: DW

3.20.24

ISSUED.


REVISED


12x24 BATH HOUSE


FRAMING LAYOUT


003

Any unauthorised use, reproduction, or distribution of these plans, whether in whole or in part, is expressly prohibited without prior written consent.

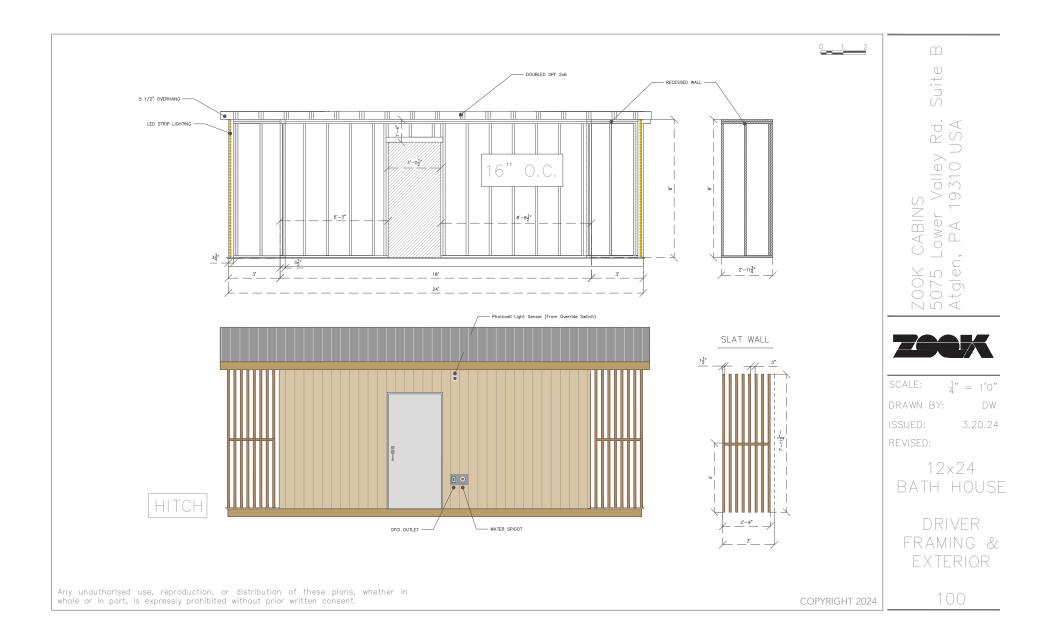

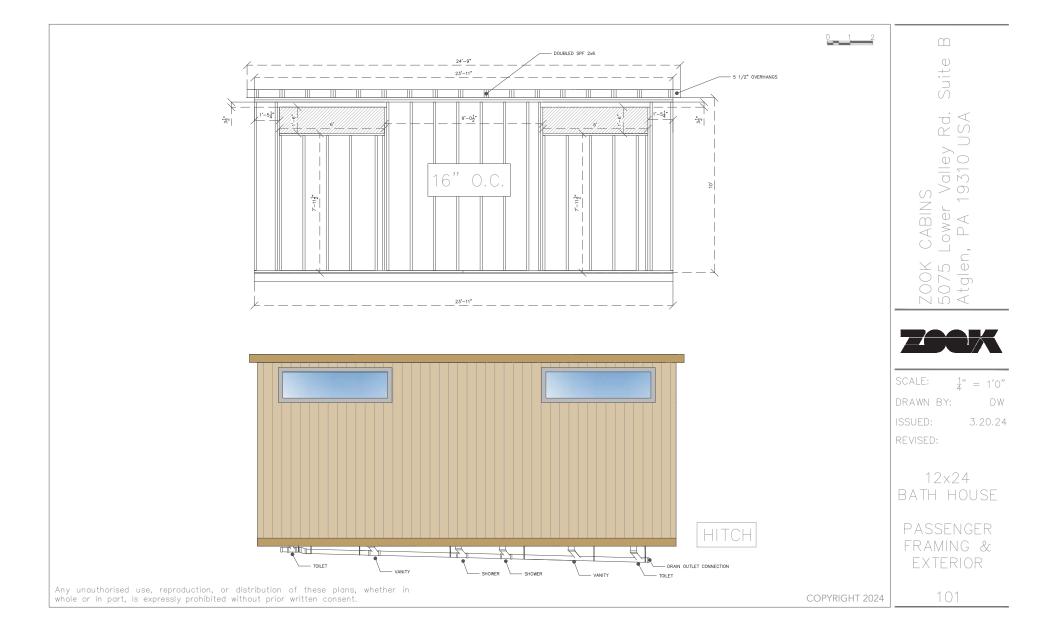

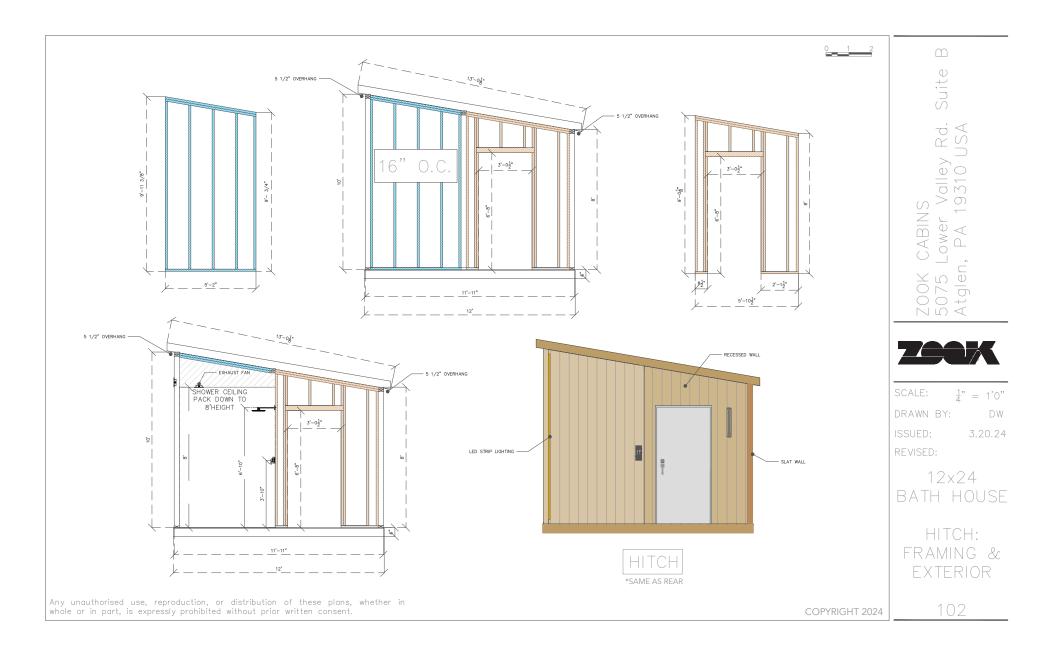

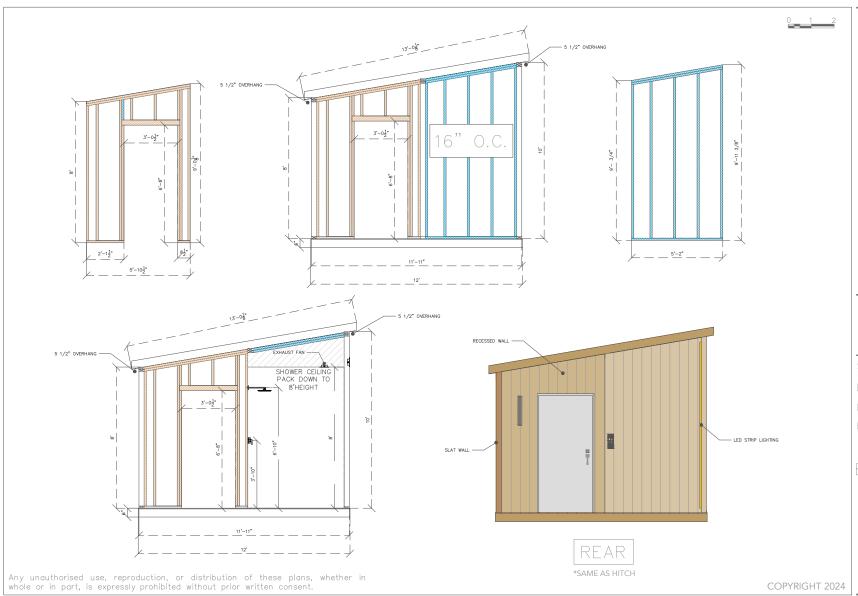



SCALE: $\frac{1}{4}$ " = 1'0"


DRAWN BY: DW

ISSUED: 3.20.24

REVISED:

12x24 BATH HOUSE

> REAR: FRAMING & EXTERIOR

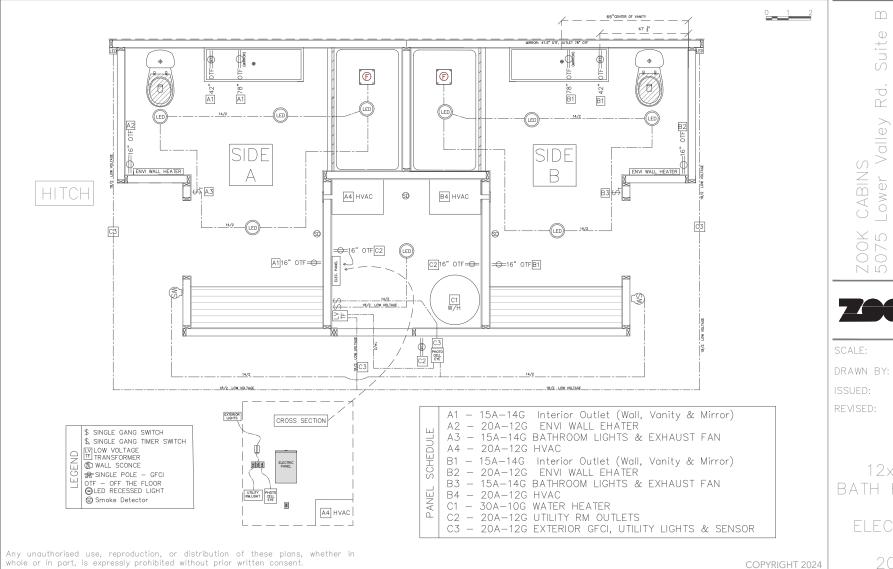

Rd. Valley 9310 U Lower 1, PA ZOOK 5075 Atgler




 $\frac{1}{4}$ " = 1'0"


DW 3.20.24


12x24 BATH HOUSE

ELECTRIC

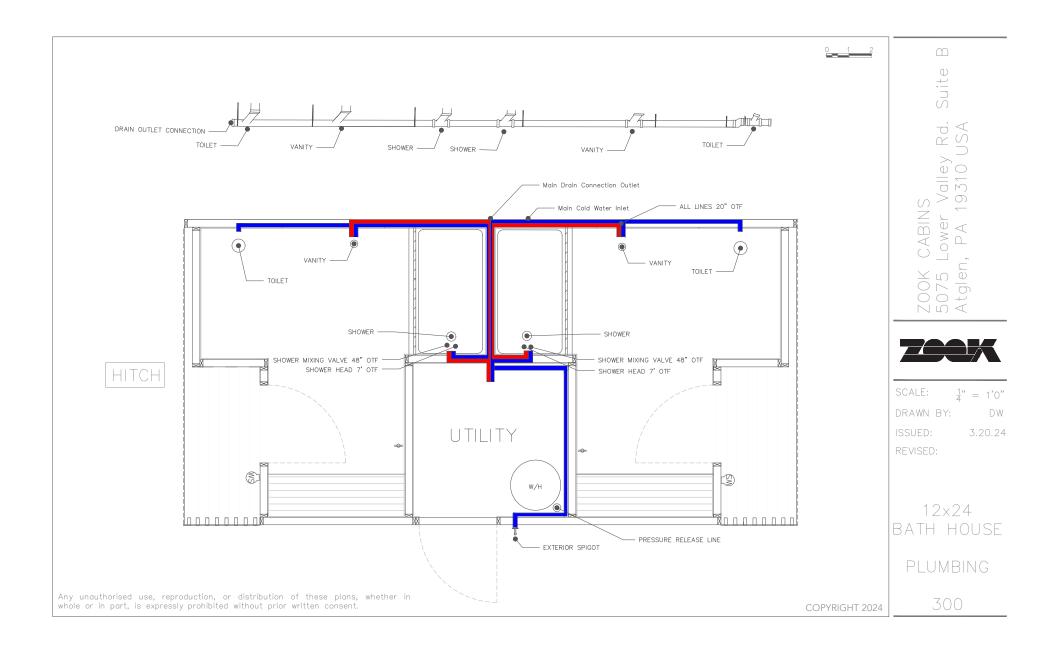


Sauna

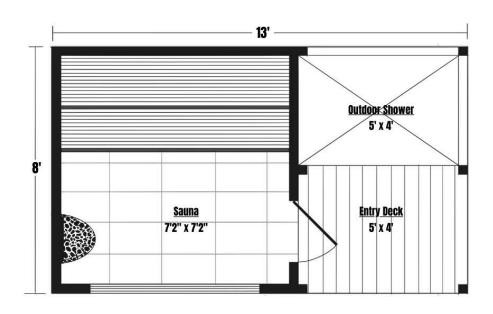

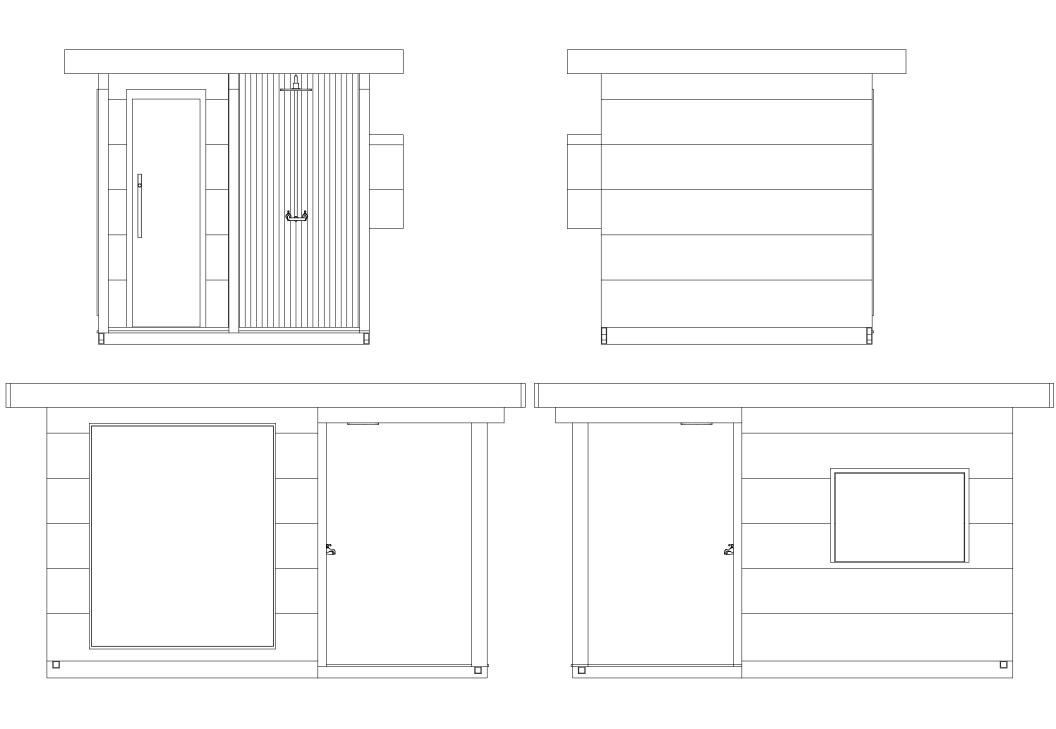



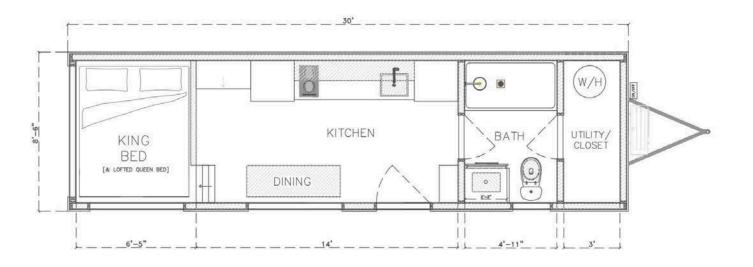



SCALE: $\frac{1}{4}$ " = 1'0"

DRAWN BY:

ISSUED: 5.3.24

REVISED:

5.28.24

DW


BASE

THE 30' NOOK

FLOOR PLAN V1

001

Any unauthorised use, reproduction, or distribution of these plans, whether in whole or in part, is expressly prohibited without prior written consent.

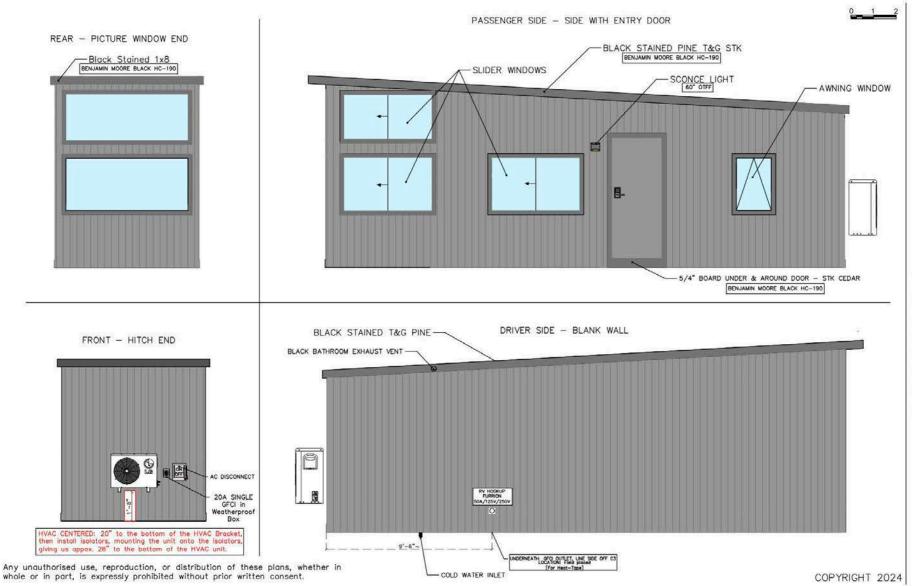

V 2.6

ZOOK CABINS 5181 Lincoln Hwy, 3ap, PA 17527 USA



SCALE: $\frac{1}{4}$ = 1'0"

DRAWN BY:

ISSUED: 5.3.24

DW

REVISED: 12.10.24

BASE

THE 30' NOOK

EXTERIOR

\mathbf{m}

ZOOK CABINS 5075 Lower Valley Rd. Atglen, PA 19310 USA



SCALE: $\frac{1}{4}$ " = 1'0" DRAWN BY:

ISSUED:

5.3.24

DW

5.28.24


REVISED:

THE 24' NOOK


FLOOR PLAN V1

001

2 4 ' PARK MODEL

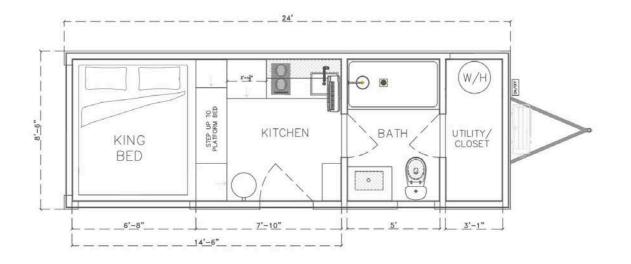

Any unauthorised use, reproduction, or distribution of these plans, whether in whole or in part, is expressly prohibited without prior written consent.

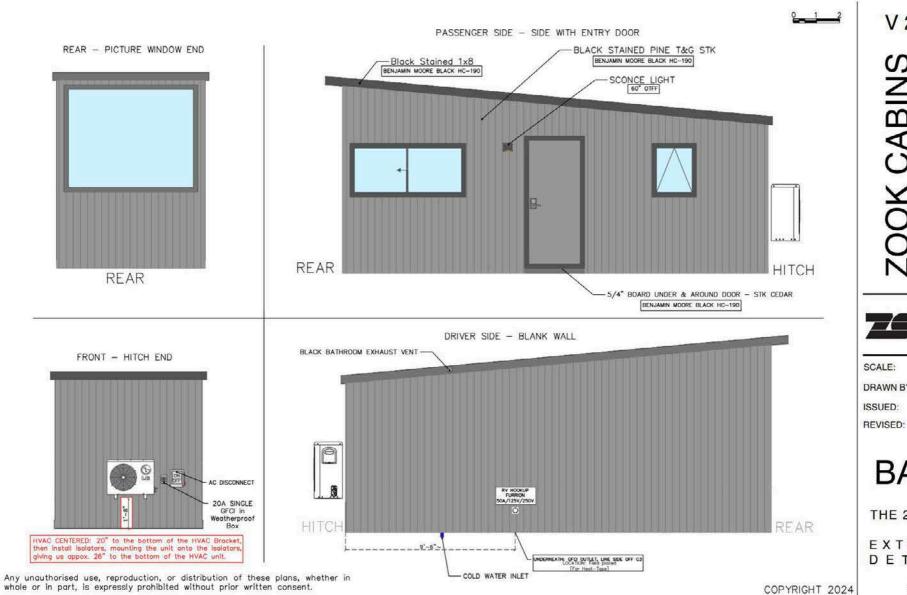

V 2.6

_ ~ 0 2 _ -X



SCALE: $\frac{1}{4}$ " = 1'0"

DRAWN BY:

ISSUED: 5.3.24


DW

12.10.24

BASE

THE 24' NOOK

EXTERIOR DETAILS

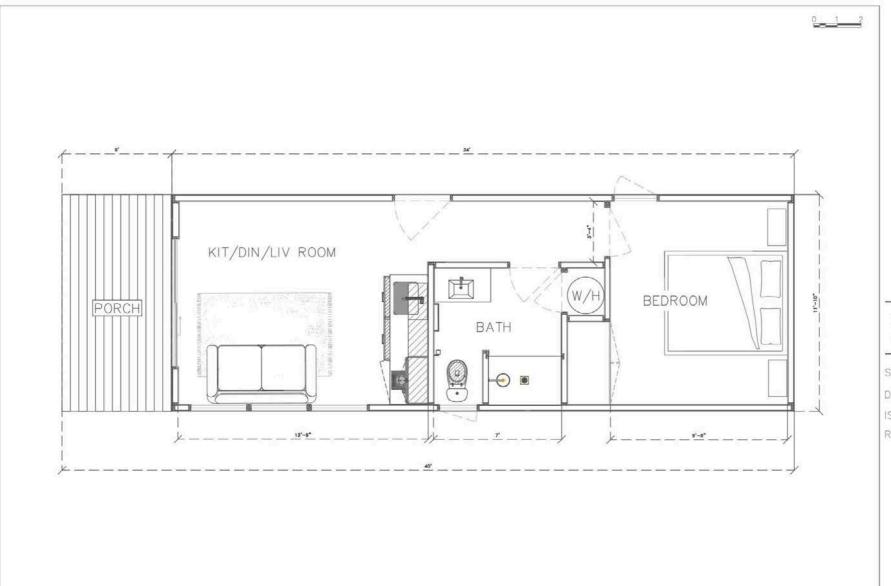



SCALE: $\frac{1}{4}$ " = 1'0"

DRAWN BY: DW

ISSUED: 3.28.24

REVISED:


12x34

ROCKWOOD

FLOOR PLAN

001

Any unauthorised use, reproduction, or distribution of these plans, whether in whole or in part, is expressly prohibited without prior written consent.

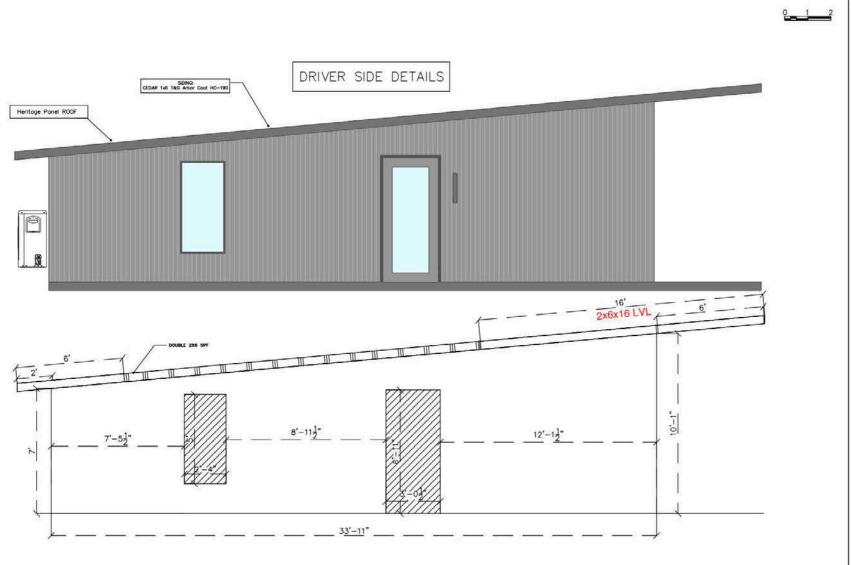

ZeeK

SCALE: $\frac{1}{4}$ " = 1'0"

DRAWN BY: DW ISSUED: 2.21.24

REVISED: 11.12.24

12x34 ROCKWOOD

DRIVER: FRAMING & EXTERIOR





SCALE: $\frac{1}{4}$ " = 1'0"

DRAWN BY: ISSUED: 2.21.24

DW

11.12.24


REVISED:

12x34 ROCKWOOD


PASSENGER: FRAMING & **EXTERIOR**

101

COPYRIGHT 2024

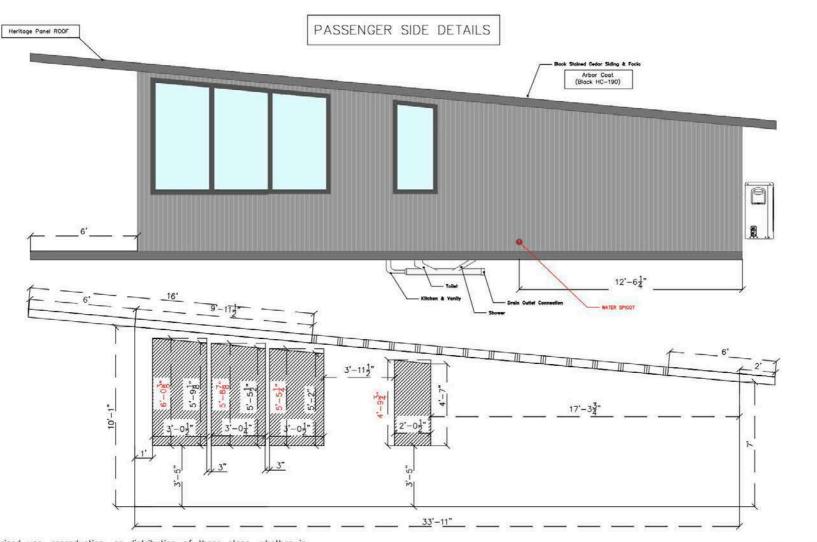

Any unauthorised use, reproduction, or distribution of these plans, whether in whole or in part, is expressly prohibited without prior written consent.

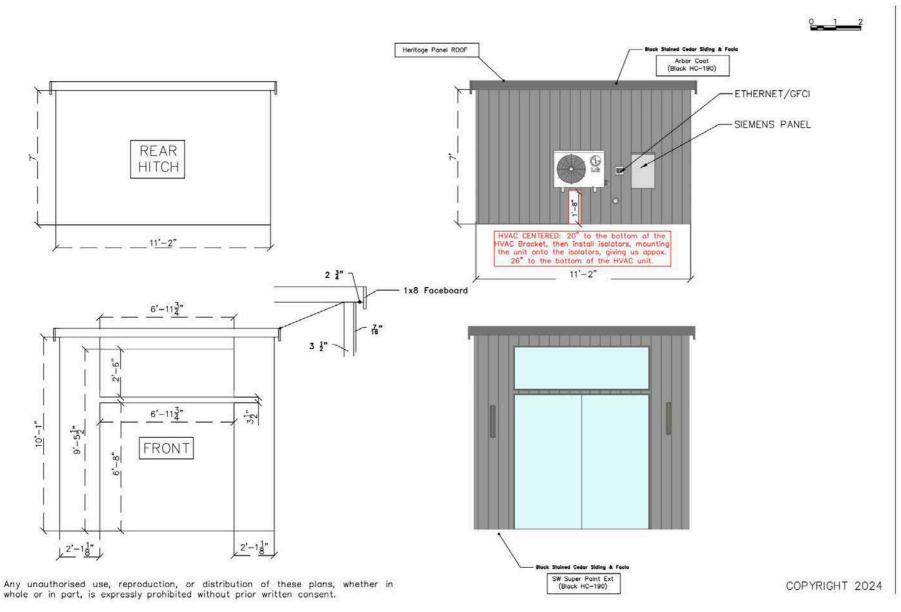

V. 2.6

ZOOK CABINS 5075 Lower Valley Rd. Suite B Atglen, PA 19310 USA



SCALE:

 $\frac{1}{4}$ " = 1'0"

DRAWN BY:

ISSUED:

2.21.24


DW

REVISED:

SED: 11.12.24

12x34 ROCKWOOD

FRONT & REAR: FRAMING & EXTERIOR

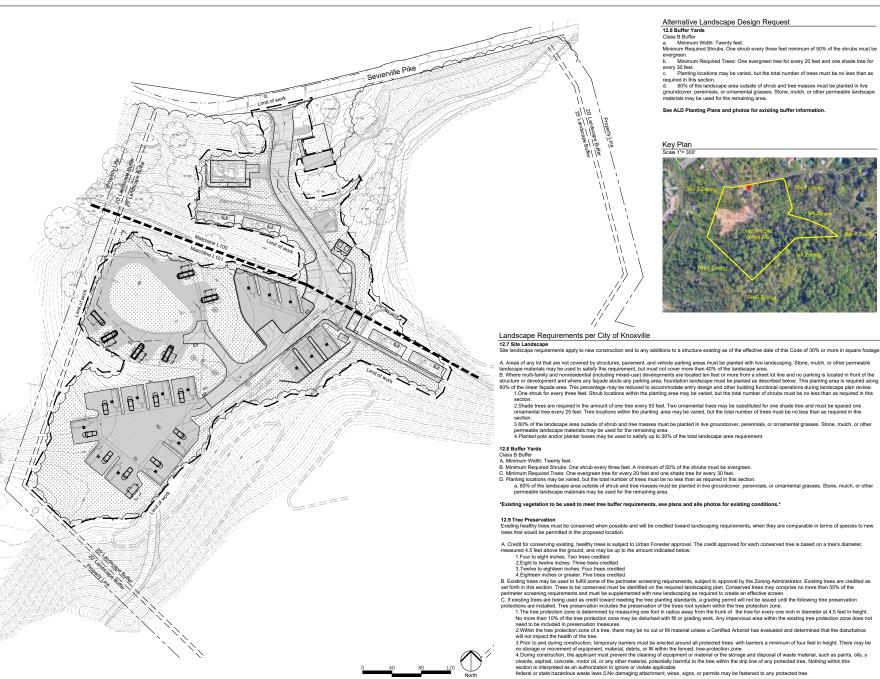

Alternative Landscape Design Request

Minimum Width: Twenty feet

Minimum Required Shrubs: One shrub every three feet minimum of 50% of the shrubs must be

- Minimum Required Trees: One evergreen tree for every 20 feet and one shade tree for
- every 30 feet.

 c. Planting locations may be varied, but the total number of trees must be no less than as
- 60% of the landscape area outside of shrub and tree masses must be planted in live groundcover, perennials, or ornamental grasses. Stone, mulch, or other permeable landscape materials may be used for the remaining area.

See ALD Planting Plans and photos for existing buffer information.



A. Areas of any lot that are not covered by structures, pavement, and vehicle parking areas must be planted with live landscaping. Stone, mulch, or other permeable

An Association of the fact in the Correctory of a structure of the Correctory of the

1. One shrub for every three feet. Shrub locations within the planting area may be varied, but the total number of shrubs must be no less than as required in this

Securion:

2. Shade trees are required in the amount of one tree every 50 feet. Two ornamental trees may be substituted for one shade tree and must be spaced one ornamental tree every 25 feet. Tree locations within the planting area may be varied, but the total number of trees must be no less than as required in this

- - a. 60% of the landscape area outside of shrub and tree masses must be planted in live groundcover, perennials, or ornamental grasses. Stone, mulch, or other

*Existing vegetation to be used to meet tree buffer requirements, see plans and site photos for existing conditions.

Existing healthy trees must be conserved when possible and will be credited toward landscaping requirements, when they are comparable in terms of species to new

B. Existing trees may be used to Itilifi some of the perimeter screening requirements, subject to approval by the Zoning Administrator. Existing trees are credited as set forth in this section. Trees to be conserved must be identified on the required indiscaping plan. Conserved trees may comprise no more than 50% of the perimeter screening requirements and must be supplemented with new landscaping as a required to create an effective screen.



4507 Sevierville Pike Knoxville, TN Drop Inn



Date: U			
Job Number: 24-029			
Drawn I	3y: LGG	Ck'c	By: SHP
Rev	Descrip	tion	Date
\neg			

Alternative Landscape Design Site Plan

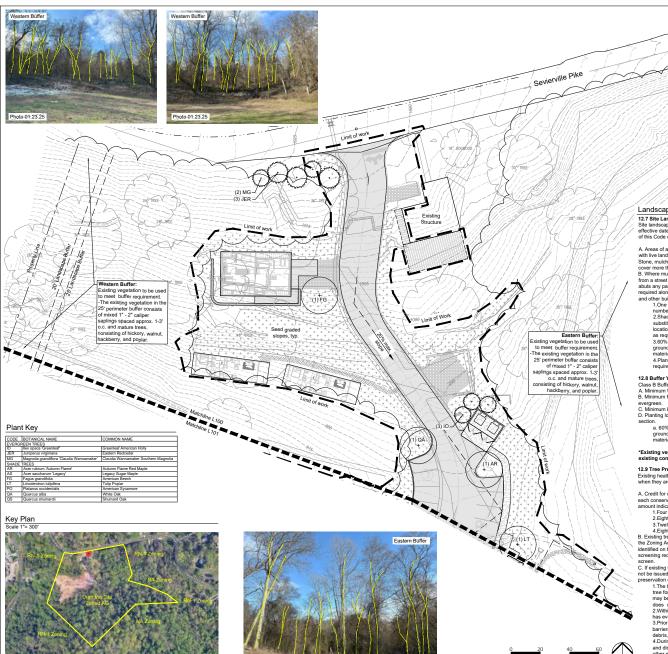


Photo 01.23.25



shall be immediately reported to the company writing. The Landscape Architect will promptly same in writing. Work done by the Control discovery of such discrepancies, inconsist while the done at the Contractor's ris

Landscape Requirements per City of Knoxville

12.7 Site Landscape

Site landscape regu irements apply to new construction and to any additions to a structure existing as of the

Photo 01.23.25

of this Code of 30% or more in square footage.

A. Areas of any lot that are not covered by structures, pavement, and vehicle parking areas must be planted with live landscaping.

Stone, mulch, or other permeable landscape materials may be used to satisfy this requirement, but must not

Northeast Buffer Existing vegetation to be used to meet buffer requirement. The existing vegetation in the

25' perimeter buffer consist of a dense bamboo stand. Northeast Buffer

cover more than 40% of the landscape area.

B. Where multi-family and nonresidential (including mixed-use) developments are located ten feet or more b. where multi-taminy and nomesterials (including most of the structure or developments are occased sen read or more from a stere lot line and no parsisentials located in front of the structure or development and where any flaçade abuts any parking rare, sloundation landscape must be planted as described below. This planting area is required along 80% of the linear flaçade area. This percentage may be reduced to accommodate entry design.

required along 60% of the linear laqued arise. Inits percentage in large for education of accommodate entry vessign and other building functional operations during landscape plan review.

1. One shrub for every three feet. Shrub locations within the planting area may be varied, but the total number of shrubs must be no less than as required in this section.

2. Shade trees are required in the amount of one tree every 50 feet. Two ornamental trees may be

substituted for one shade tree and must be spaced one ornamental tree every 25 feet. Tree locations within the planting area may be varied, but the total number of trees must be no less than as required in this section.

as required in lins secured.

3.0% of the landscape area outside of shrub and tree masses must be planted in live groundcover, perennials, or ornamental grasses. Stone, mulch, or other permeable landscape materials may be used for the remaining area.

4.Planted pots and/or planter boxes may be used to satisfy up to 30% of the total landscape area

requirement.

12.8 Buffer Yards

Class B Buffer

A Minimum Width: Twenty feet

B. Minimum Required Shrubs: One shrub every three feet. A minimum of 50% of the shrubs must be

C. Minimum Required Trees: One evergreen tree for every 20 feet and one shade tree for every 30 feet. D. Planting locations may be varied, but the total number of trees must be no less than as required in this

a. 60% of the landscape area outside of shrub and tree masses must be planted in live groundcover, perennials, or ornamental grasses. Stone, mulch, or other permeable landscape materials may be used for the remaining area.

*Existing vegetation to be used to meet tree buffer requirements, see plans and site photos for

12.9 Tree Preservation

Existing healthy trees must be conserved when possible and will be credited toward landscaping requirements when they are comparable in terms of species to new trees that would be permitted in the proposed location.

A. Credit for conserving existing, healthy trees is subject to Urban Forester approval. The credit approved for each conserved tree is based on a tree's diameter, measured 4.5 feet above the ground, and may be up to the amount indicated below:

1.Four to eight inches: Two trees credited

- 2. Eight to twelve inches: Three trees credited

3. Twelve to eighteen inches: Four trees credited
4. Eighteen inches or greater: Five trees credited
B. Existing trees may be used to fulfill some of the perimeter screening requirements, subject to approval by the Zoning Administrator. Existing trees are credited as set forth in this section. Trees to be conserved must be detailed and the required landscaping plan. Conserved trees may comprise no more than 50% of the perimete screening requirements and must be supplemented with new landscaping as required to create an effective

C. If existing trees are being used as credit toward meeting the tree planting standards, a grading permit will not be issued until the following tree preservation protections are installed. Tree preservation includes the preservation of the trees root system within the tree protection zone.

1. The tree protection zone is determined by measuring one foot in radius away from the trunk of the tree for every one inch in diameter at 4.5 feet in height. No more than 10% of the tree protection zone may be disturbed with fill or grading work. Any impervious area within the existing tree protection zone does not need to be included in preservation measures.

does not need to be included in preservation measures.

2. Within the tree protection zone of a tree, there may be no cut or fill material unless a Certified Arborist has evaluated and determined that the disturbance will not impact the health of the tree.

3. Prior to and during construction, temporary barriers must be erected around all protected trees with barriers a minimum of four feet in height. There may be no storage or movement of equipment, material, debris, or fill within the fenced, tree-protection zone.

4.During construction, the applicant must prevent the cleaning of equipment or material or the storage and disposal of waste material, such as paints, oils, solvents, asphalt, concrete, motion oil, or any other material, potentially harmful to the tree within the drip line of any protected tree. Nothing within this section is interpreted as an authorization to ignore or violate applicable

federal or state hazardous waste laws.

5.No damaging attachment, wires, signs, or permits may be fastened to any protected tree



07 Sevierville Pike Knoxville, TN

4507

Drop Inn

Date: 01.27.25

Sheet Name: Alternative

Landscape Design Site Planting Plan



a. 60% of the landscape area outside of shrub and tree masses must be planted in live

groundcover, perennials, or ornamental grasses. Stone, mulch, or other permeable landscape materials

*Existing vegetation to be used to meet tree buffer requirements, see plans and site photos for existing

3'-20' apart with understory growth

Scale 1"=20'-0"

hedstrom

shall be immediately reported to the company writing. The Landscape Architect will promptly same in writing. Work done by the Control discovery of such discrepancies, inconsist while the done at the Contractor's ris

07 Sevierville Pike Knoxville, TN Drop Inn 4507 (



Date: 01.27.25 Job Number: 24-029			
Drav	vn By: LGG	Ck'd By: SHP	
Rev	Description	n Date	
_			

Sheet Name: Alternative

Landscape Design Site Planting Plan

trees with barriers a minimum of four feet in height. There may be no storage or movement of equipment, material, debris, or fill within the fenced, tree-protection zone. 4. During construction, the applicant must prevent the cleaning of equipment or material or

ignore or violate applicable federal or state hazardous waste laws.

5.No damaging attachment, wires, signs, or permits may be fastened to any protected tree.

the storage and disposal of waste material, such as paints, oils, solvents, asphalt, concrete, motor oil, or any other material, potentially harmful to the tree within the drip line of any protected tree. Nothing within this section is interpreted as an authorization to

Planting Notes

- Contractor shall verify all existing conditions in the field and report any discrepancies to the Landscape Architect or Owner's Representative prior to starting
- The Contractor shall locate and verify all existing utility lines prior to planting and report any conflicts to the Landscape Architect or Owner's Representative.

- Contractor's base bid to include all materials, labor, permits, equipment, tools, insurance, etc. to perform the work as described in the contract documents. Contractor to complete work within schedule established by Owner. Contractor to provide one year warranty for all material from date of substantial completion. Contractor to provide interim maintenance (watering, pruning, fertilizing, guying, moving, trimming, adequate drainage of ponding areas, edging, weeding, mulching, and general landscape clean-up) until substantia completion notice is provided by the Landscape Architect or Owner's Representative. Application of insecticides/herbicides must be approved by Landscape Architect or Owner's Representative provided by the Candscape Architect or Owner's Representative prior to use on site.
- No planting shall occur until soil sample results have been received from all planting areas and soils are properly amended based on the results of the soil tests. See Soil Sample Notes on this sheet.
- No planting shall occur until percolation testing has been completed and soils have been properly amended to drain. See Percolation Test Notes on this
- 8. All new plant material shall conform to the guidelines established for nursery stock published by the American Association of Nurserymen, Inc. In addition all new plant material for the project shall be of the highest specimen quality. Plant material delivered to the site that does not meet the requirements stated herein may be rejected by the Landscape Architect or Owner's Representative.

 9. All new plants shall be balled and burlapped or container grown unless otherwise noted on the plant list.

 10. Any proposed substitutions of plant species shall be made with plants of equivalent overall form, height, tranching habit, flower, leaf, color, fruit, and

- culture only as approved by the Landscape Architect or Owner's Representative.

 11. Do not assume trunk flare will be exposed at the nursery. Contractor to expose trunk flares to check for root girdling. Pull mulch away from the trunk flare of trees and from the base of all shrubs.
- 12. No plant material shall be planted before acceptance of rough grading. The finished grade shall not cover any part of the tree trunk flare. See tree planting
- Planting plans are not layout plans. Plants may need to be shifted in the field, based on the existing conditions. Stake location of all proposed trees and planting areas for approval by the Landscape Architect or Owner's Representative prior to the commencement of planting. Coordinate with the Landscape Architect or Owner's Representative prior to any changes.
- Shade trees to be planted a minimum of 5" from sidewalks, water line, sewer line or manholes. Evergreen and ornamental trees to be planted a minimum of 5" from sidewalks, water line, sewer line or manholes.

 15. Plant be

- 13. Hain beds of part mass of waiss at all argic devicement as a did out of the second of the second
- soak in and repeat until the proper depth is wet.

 19. See Civil Plans for further information regarding:

 Erosion and sediment control
- Locations of existing and proposed structures, paving, driveways, cut and fill areas, and retention areas
- Limits of Work
 Locations of existing and proposed utilities or easements

Abbreviations:

B&B: Ball & Burlap	CAL: Caliper	CT: Clear Trunk
HGT: Height	FTG: Full to ground	GAL: Gallon
MIN: Minimum	MT: Multi-trunk	OC: On Center
DBH: Diameter at breas	t height	

Plant Schedule

	_		1			1
CODE	QTY	BOTANICAL NAME	COMMON NAME	SIZE	CONTAINER	REMARKS
EVERG	REEN T	REES				
10	3	llex opaca 'Greenleaf'	Greenleaf American Holly	8' hgt.	B&B	FTG, full and dense
JER	3	Juniperus virginiana	Eastern Redcedar	8' hgt.	B&B	FTG, full and dense
MG	2	Magnolia grandiflora 'Claudia Wannamaker'	Claudia Wannamaker Southern Magnolia	8' hgt.	B&B	Full and dense
SHADE	SHADE TREES					
AR	2	Acer rubrum 'Autumn Flame'	Autumn Flame Red Maple	2" cal.	B&B	6' CT, CL, full and well branched
AS	6	Acer saccharum 'Legacy'	Legacy Sugar Maple	2" cal.	B&B	6' CT, CL, full and well branched
FG	1	Fagus grandifolia	American Beech	2" cal.	B&B	5' CT, CL, full and well branched
LT	5	Liriodendron tulipifera	Tulip Poplar	2" cal.	B&B	6' CT, CL, full and well branched
PO	1	Platanus occidentalis	American Sycamore	2" cal.	B&B	6' CT, CL, full and well branched
QA	3	Quercus alba	White Oak	2" cal.	B&B	5' CT, CL, full and well branched
QS	3	Quercus shumardii	Shumard Oak	2" cal.	B&B	5' CT, CL, full and well branched

Planting Soil Composition Notes

The Landscape Subcontractor shall provide sufficient planting soil to fulfill all planting operations required of the Contract Documents. Planting soil shall comply with the following notes:

- Planting soil shall be topsoil stripped and stockpiled and meeting, or modified to meet,
- Textural Analysis of soil to be between sandy clay loam and clay loam, with a clay content between 15 and 25% and an organic content of 4% by dry weight.

 Planting soil shall be free of plants and their roots, debris and other extraneous matter. It
- Shall be uncontaminated by sall water, foreign matter and substances harmful to plant growth. All soil to be free of all rocks, limestone, gravel, & foreign construction debris.

 Soil additives shall be used to counteract soil deficiencies are recommended by the soils analysis conducted by Waypoint Analytical. See Soil Sampling notes, this sheet.
- 5. Soil pH target to be 6.0.6. Soil to be installed in maximum 6" lifts. Soil compaction rating to be 85%.
- 7. Soil particle size shall have 90% passing rate on 7" screen and 100% of material shall

Percolation Test Notes

- Dig a hole 18-24" deep & a minimum of 6" wide. Fill hole with water to the top and let drain for several hours. Ideally let the hole pre-wet over night and test the following day.
- Refill hole to within a couple inches of the top
- To aid in measurement, place a stick across the top of the hole and use a second stick to mark periodic drops in water level; mark side of hole; or mark soil on side of hole with nail or stick.
- Measure drop in water level after 30 minutes and one hour. If possible measure weasure utop in water level after 30 minutes and one frour. If possible measure drop in water level the next day.

 Determine drop in water level per hour. If water level in hole drops more than
- one inch per hour, it is well drained and suitable for all plant specie

Existing Soil Sampling Notes

- Using a spade, dig a v-shape hole to a 6" depth; then cut a thin slice of soil from one side of the hole. Place the slice in a plastic bucket, do not use a metal bucket. Mix slices together and fill a plastic sample bag with three (3) cups of dirt. The sample bags can be Ziploc bags that are

labeled with the project name and sample number.

A well mixed composite from 10 to 20 random locations should be

- subsampled to make the three (3) cup sample.
- Mark the plan to show soil sample locations.

 Send samples to Waypoint Analytical Labs, Inc., 2790 Whitten Road, Memphis, Tennessee 38133, (901)213-2400, waypointanalytical.com.
- Results shall be copied to the Owne



Planting soil, see Planting Soil Composition

 Excavate tree bed to required depth and backfill with planting soil mix which shall be continuous within each shrub bed. Rough grade to remain on slope. Undisturbed subgrade or compacted backfill must percolate. See Percolation Test Notes on this sheet

Note: Rake or till soil surface along the

TREE SLOPE PLANTING



TREE PLANTING

ee shall be plumb after settlement. ontractor shall stake.

Contractor shall stake.

Trunk flare of each tree shall be exposed. Set tree so that no part of the trunk flare is buried. Do not cover the trunk flare with mulch.

Apply Tree Saver mycorrhiza or approved equal at time of tree planting.

1.5" Mulch (pull mulch away from trunk of tree

Excavate hole to diameter 2x wider than rootball. Backfill hole with sandy loam planting soil mix consisting of 50-80% medium and coarse sand << fine sand, 5-20% clay, and 5-35% sit with a pH 6 unless otherwise noted.

Excavate topsoil substrate as required to place rootball to proper elevation. Place rootball directly on undisturbed substrate or compared.

planting medium.



Any discrepancies, moubetween the diswirgs, specifications, enshall be immediately reported to the Landscepe a writing. The Landscepe Architect will promptly same in writing. Work done by the Contr discovery of such discrepancies, incorais' —Novalbas shall be done at the Contractor's ris

Pike Drop Inn Sevierville P (noxville, TN Knoxville, 4507



	0.000	0.0000000000000000000000000000000000000	
Date: 0	1.27.25		
Job Nu	mber: 24-0	29	
Drawn I	By: LGG	Ck'd E	3y: SHP
Rev	Descrip	tion	Date

Sheet Name:

Plant Schedule, Notes, & Details

Sheet Number:



Development Request

DEVELOPMENT ☐ Development Plan ☐ Concept Plan ☐ Planned Development ☐ Final Plat ☐ SP ☐ PA ☐ WUse on Review / Special Use ☐ Hillside Protection COA

PIER Group LLC Owner			r	
Applicant Name	Affiliation			
1/27/2025	March 13, 2	2025		File Number(s)
Date Filed	Meeting Date (if applicable) 3-E-25-SU		25-SU	
CORRESPONDENCE All corre	espondence related	to this application should be di	rected to the ap	proved contact listed below.
■ Applicant ■ Property Owner □	Option Holder	☐ Project Surveyor ☐ Engi	neer 🗌 Archit	ect/Landscape Architect
Nadim Jubran		PIER Group LLC		
Name		Company		
121 E. Jackson Ave.		Knoxville	TN	37915
Address		City	State	ZIP
865-300-4748				
Phone	Email			
CURRENT PROPERTY INFO				
PIER Group LLC	648	0 Kingston Pike		865-300-4748
Property Owner Name (if different)	Prope	erty Owner Address		Property Owner Phone
4507 Sevierville Pike		109LD0	06	
Property Address	Parcel ID			
Knoxville Utilities Board (KUB)	Knoxville Utilities Board(KUB) N		N	
Sewer Provider	Water Provider		Septic (Y/N)	

COMMUNITY ENGAGEMENT

Sign and return the **Public Notice & Community Engagement** form with this application.

Planning strives to provide community members with information about upcoming cases in a variety of ways. In addition to posting public notice signs, our agency encourages applicants to provide information and offer opportunities for dialogue related to their upcoming case(s). **We require applicants to acknowledge their role in this process.**

DEVELOPMENT REQUEST			
☐ Development Plan ■ Use on Review / Special Use ☐ Hillside Protection COA			Related City Permit Number(s)
☐ Residential ☐ Non-Residential			4-E-23-SU
Home Occupation (specify)			
Other (specify) — Campground - Revision to p	revious Specia	l Use approval	
SUBDIVISION REQUEST			
			Related Rezoning File Number
Proposed Subdivision Name			
Combine Parcels	☐ Divide Parcel	Total Number of Lots Created	
Unit / Phase Number		Total Number of Lots Created	
Other (specify)			
☐ Attachments / Additional Requirements			
ZONING REQUEST			
			Pending Plat File Number
Zoning Change Proposed Zoning			
☐ Plan Amendment Change Proposed Plan Desi			
Proposed Plan Desi	gnation(s)		
Proposed Density (units/acre) Prev	vious Rezoning Re	quests	
Other (specify)			
STAFF USE ONLY			
PLAT TYPE		Fee 1	Total
☐ Staff Review ☐ Planning Commission			
ATTACHMENTS ☐ Property Owners / Option Holders ☐ Variance	ce Request	Fee 2	
☐ Amendment Request (Comprehensive Plan)	oc nequest		\$1,600.00
ADDITIONAL REQUIREMENTS		Fee 3	
☐ Use on Review / Special Use (Concept Plan) ☐ Traffic Impact Study		100 3	
COA Checklist (Hillside Protection)			
AUTHORIZATION			
By signing below, I declare under penalty of perjury t			
 The application and all associated materials are bein holders, each <u>additional</u> individual must sign the Property 			tional owners or options
72.5	Nadim Jub	ran (PIER Group LLC)	1/26/25
Applicant Signature	Print Name /	Affiliation	Date
865-300-4748			
Phone Number	Email		
42	Nadim Jub	ran (PIER Group LLC)	1/27/2025, SG

Please Print

Date Paid

Property Owner Signature



Public Notice and Community Engagement

Sign Posting and Removal

The Administrative Rules and Procedures of the Knoxville-Knox County Planning Commission require a sign to be posted on the property for each application subject to consideration by the Planning Commission.

Planning staff will post the required sign. If a replacement sign(s) is needed, the applicant is responsible for picking up the new sign(s) from Planning and will be charged \$10 for each replacement.

Location and Visibility

The sign must be posted on the nearest adjacent/frontage street and in a location clearly visible to vehicles traveling in either direction. If the property has more than one street frontage, the sign should be placed along the street that carries more traffic. Planning staff may recommend a preferred location for the sign to be posted at the time of application.

Timing

The sign(s) must be posted not less than 12 days prior to the scheduled Planning Commission public hearing and must remain in place until the day after the meeting. In the case of a postponement, the sign can either remain in place or be removed and reposted not less than 12 days prior to the next Planning Commission meeting. The applicant is responsible for removing the sign after the application has been acted upon by the Planning Commission.

Community Engagement

Planning strives to provide community members with information about upcoming cases in a variety of ways. In addition to posting public notice signs, our agency encourages applicants to provide information and offer opportunities for dialogue related to their upcoming case(s).

Acknowledgement		Have you engaged the
By signing below, you acknowle posted and visible on the property	surrounding property owners to discuss your request?	
and between the dates listed below.		☐ Yes ☐ No
3 /1/202 5 2/28/2025 3/14/2025		☐ No, but I plan to prior to the Planning Commission meeting
Date to be Posted	Date to be Removed	

Nadim Jubran (PIER Group LLC)

1.26.25 Date

Applicant Signature

Applicant Name

3-E-25-SU